








PREPARED BY :	PREPARED BY :	APPROVED AND REVIEWED BY	PROJECT TITLE :	SHEET CONTENT:	
JANSEN GABRIEL S. LIM ENGINEER	JOHN V PACETE ARCHITECT	ENGR. MARK P TORRES OIC - ENGINEERING & SOCIAL SUPPORT DEPARTMENT	"STP, ACCESS ROAD AND FREEDOM PARK"	VICINITY MAP	
DATE:	DATE:	DATE:	LOCATION: PASONG TAMO EXTENSION, TAGUIG CITY		


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JANSEN GABRIEL S. LIM

ENGINEER

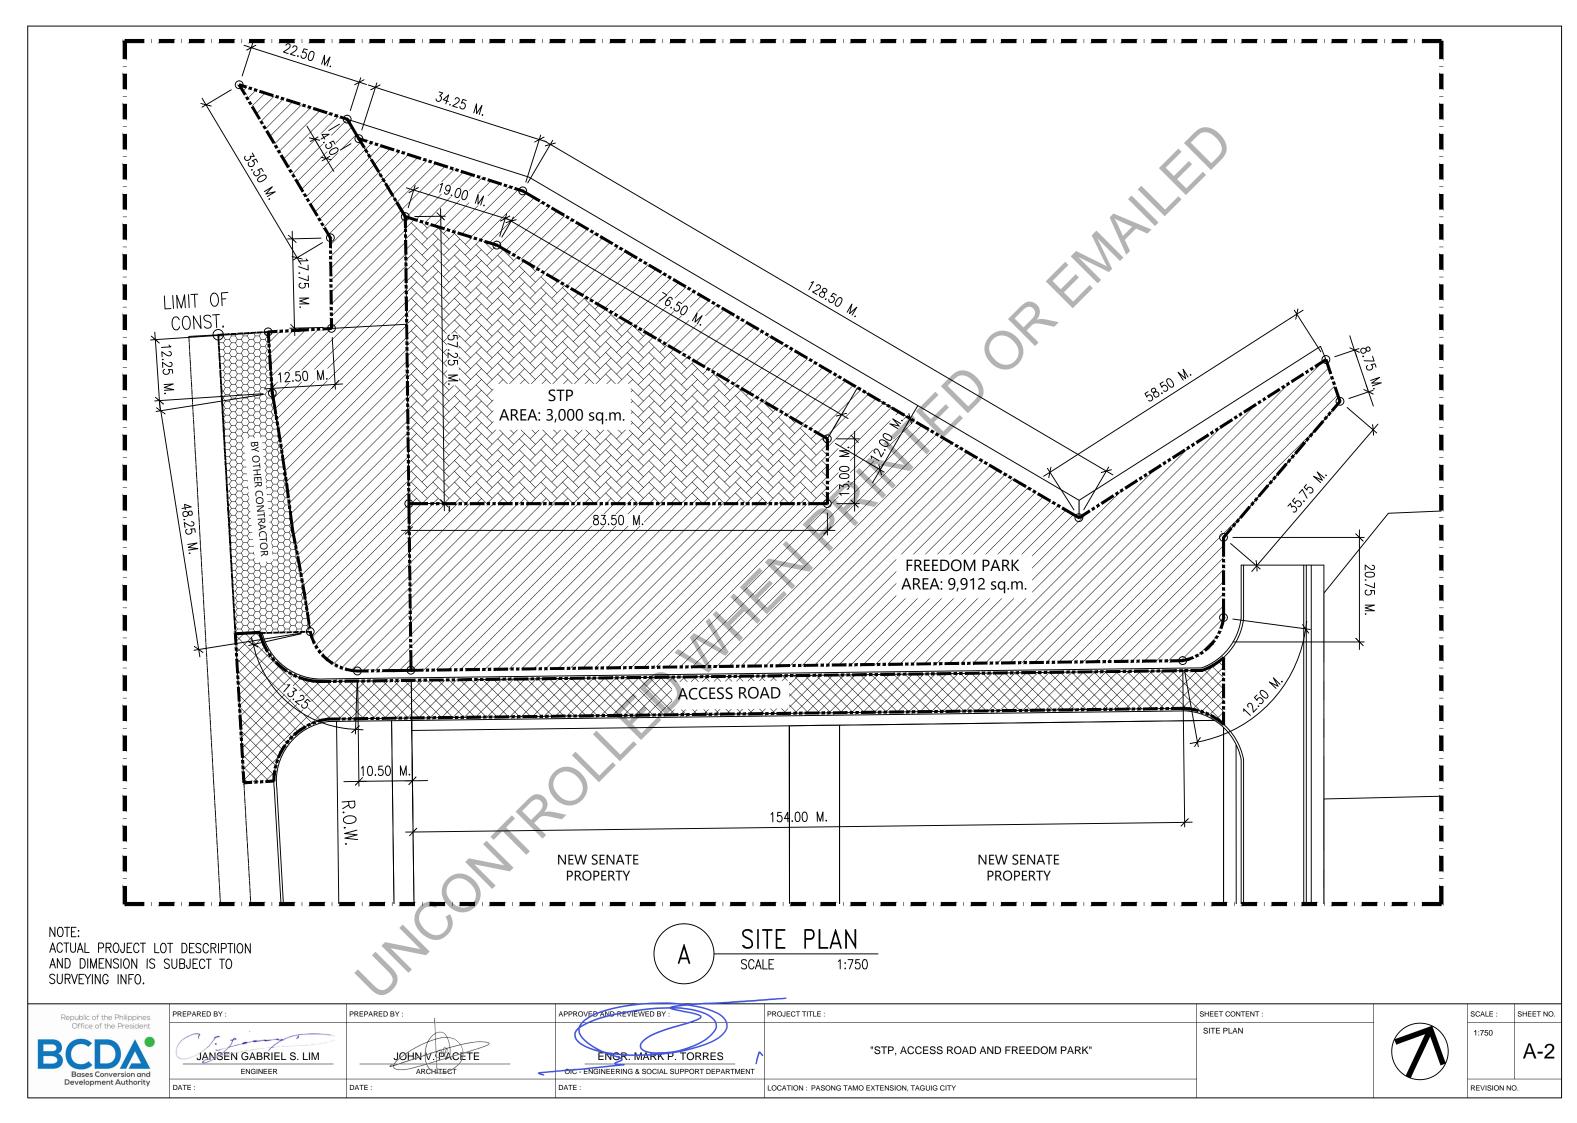PREPARED BY:

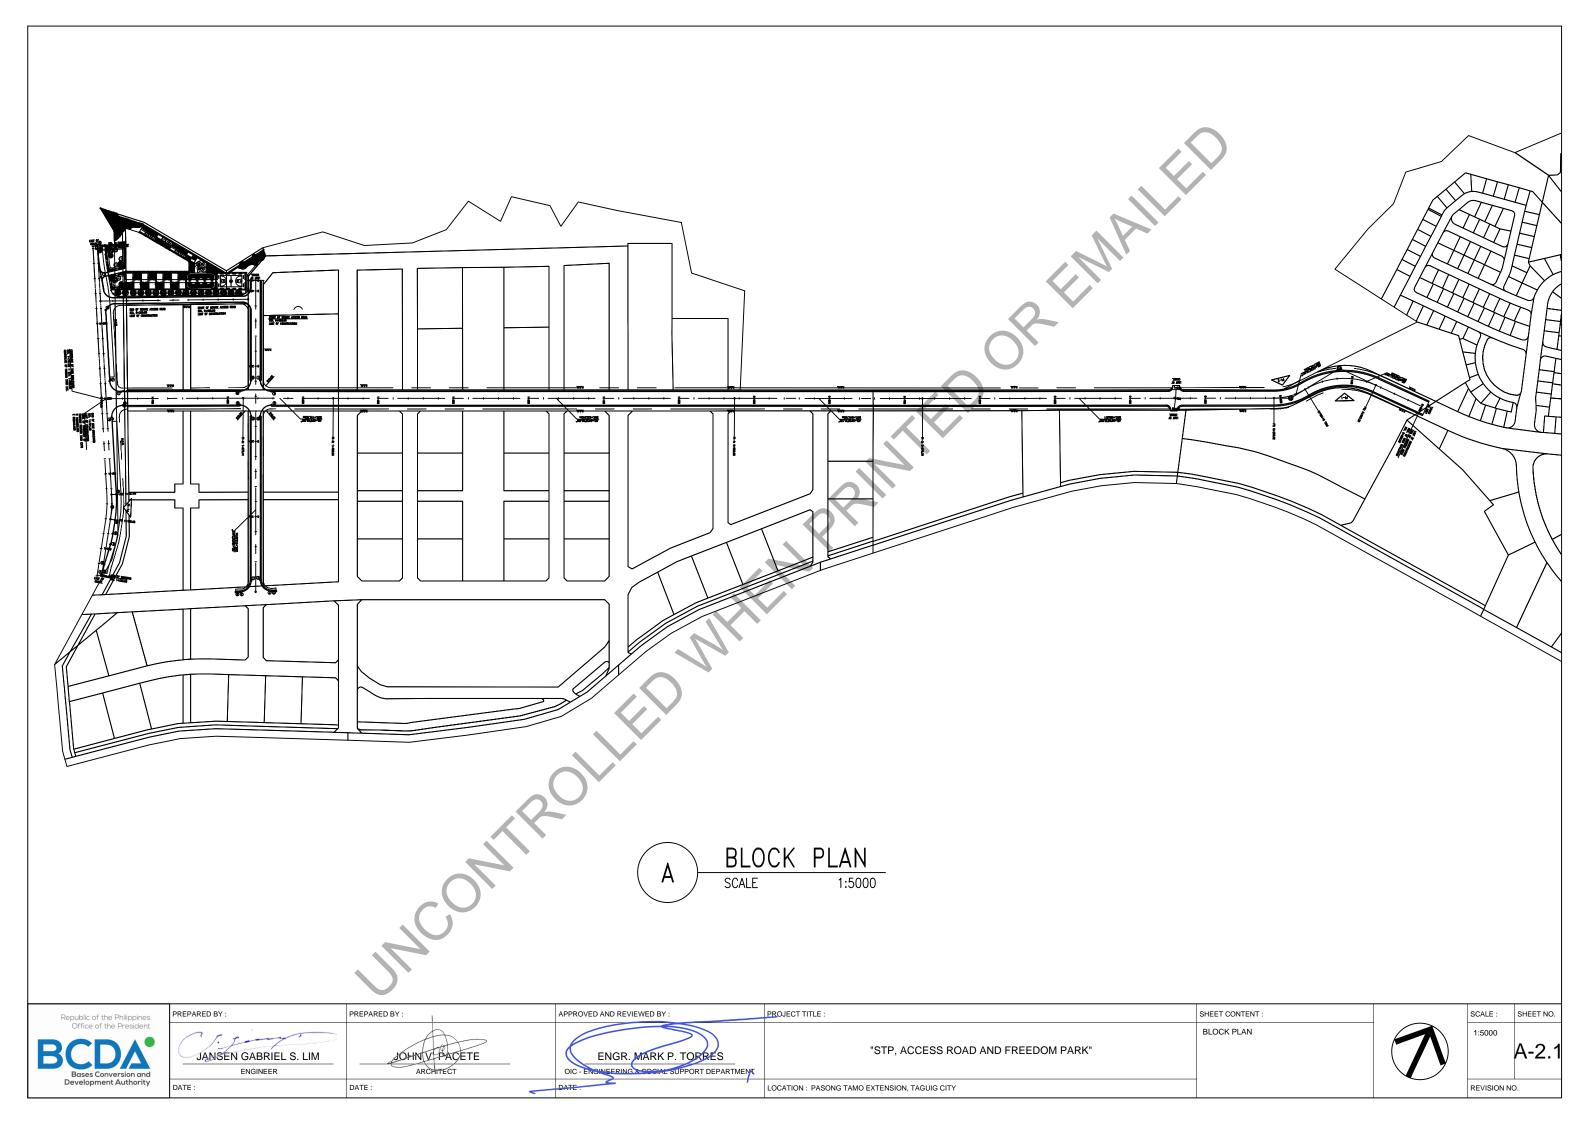APPROVED AND REVIEWED BY:

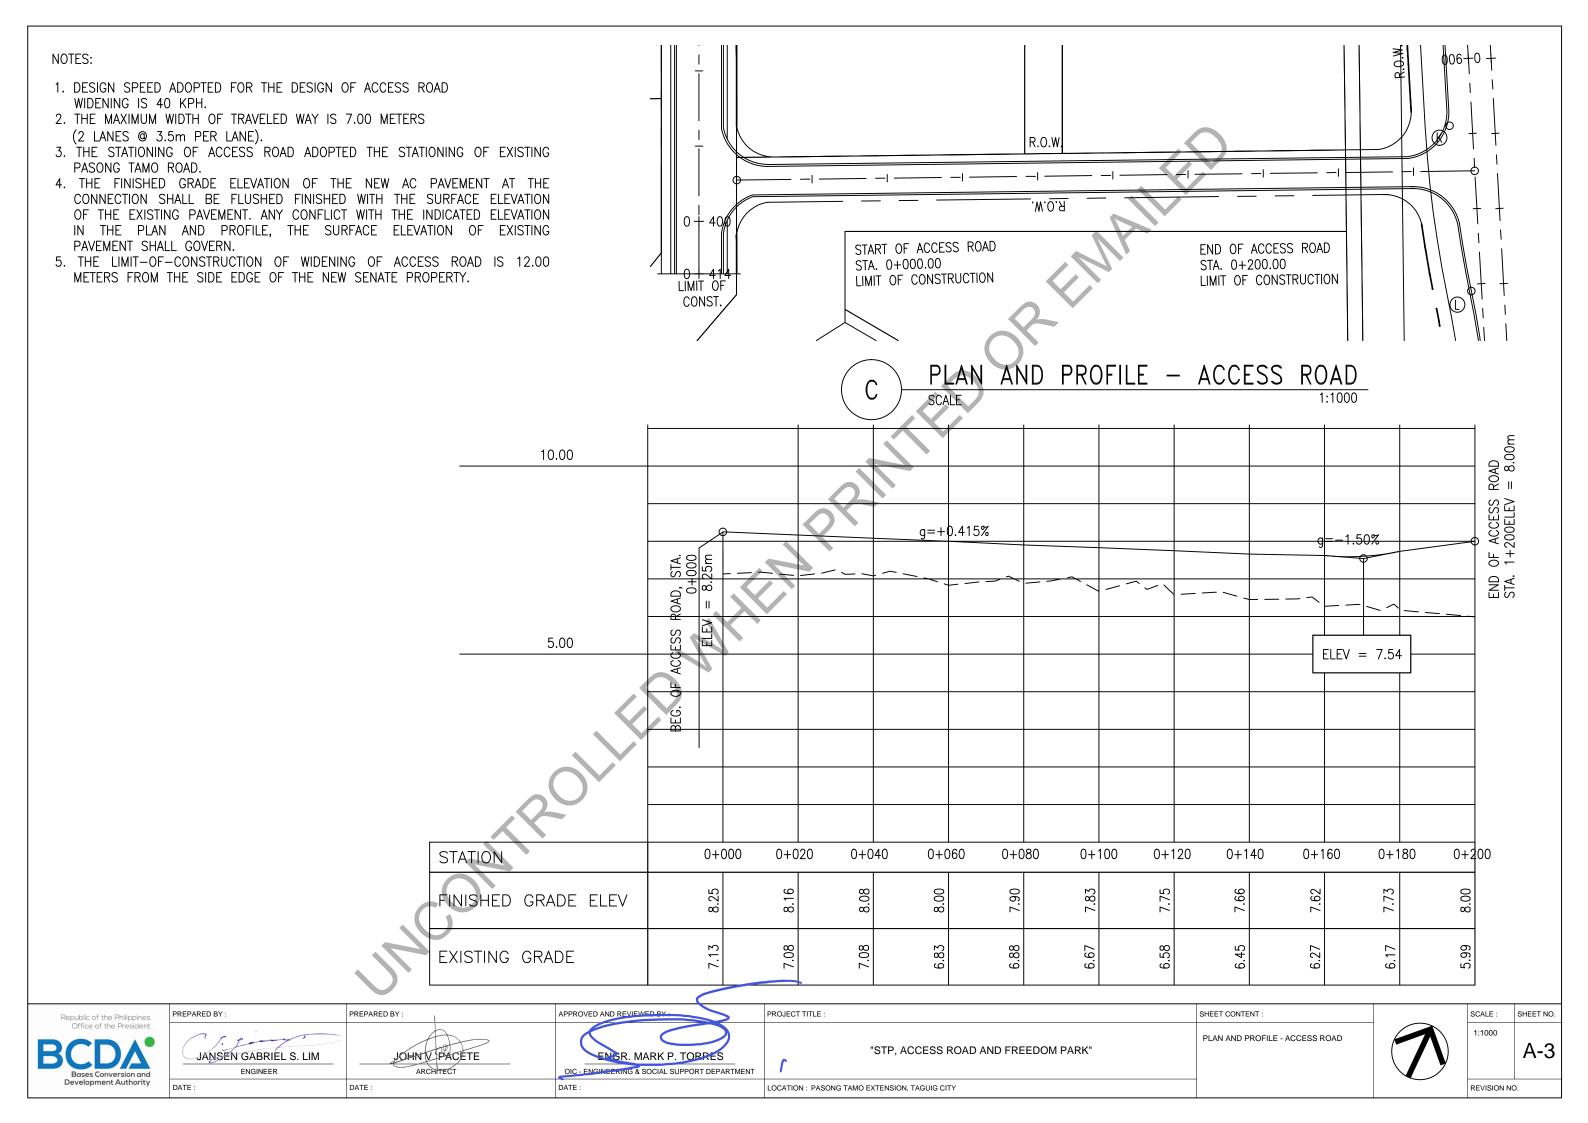PROJECT TITLE:

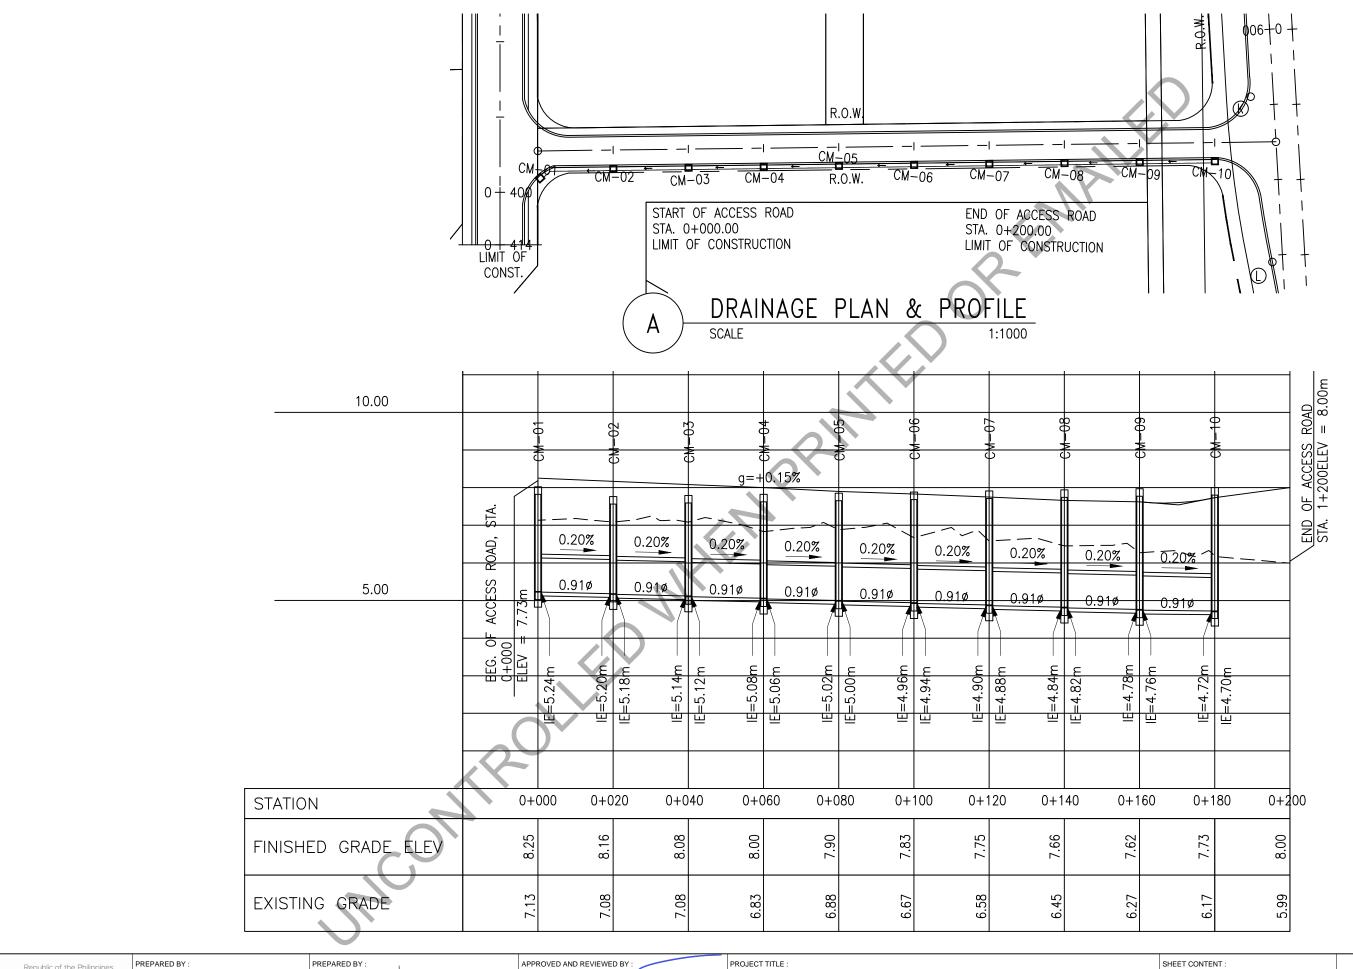SHEET CONTENT:

DRAINAGE PLAN & PROFILE - ACCESS ROAD AND FREEDOM PARK"


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LOCATION: PASONG TAMO EXTENSION, TAGUIG CITY




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	REVISION NO)





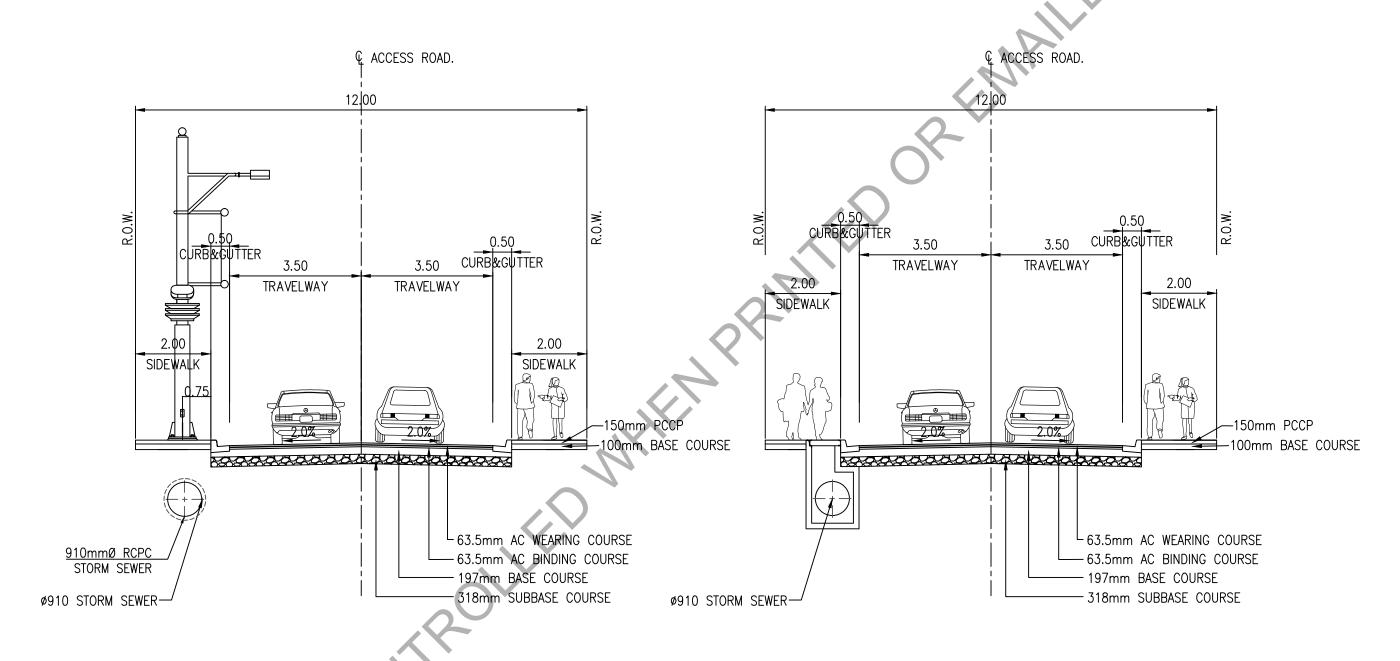

oines	PREPARED BY :	PREPARED BY :	APPROVED AND REVIEWED BY:	PROJECT TITLE :	SHEET CONTENT :	SCALE :	SHEET NO.
and	JANSEN GABRIEL S. LIM ENGINEER	JOHN V PACETE ARCHITECT	ENGR. MARK P. TORRES OIG ENGINEERING & SOCIAL SUPPORT DEPARTMENT	"STP, ACCESS ROAD AND FREEDOM PARK"	TYPICAL CROSS SECTION DETAILS	1:100	A-5
ority	DATE:	DATE:	DATE:	LOCATION : PASONG TAMO EXTENSION, TAGUIG CITY		REVISION NO	Э.

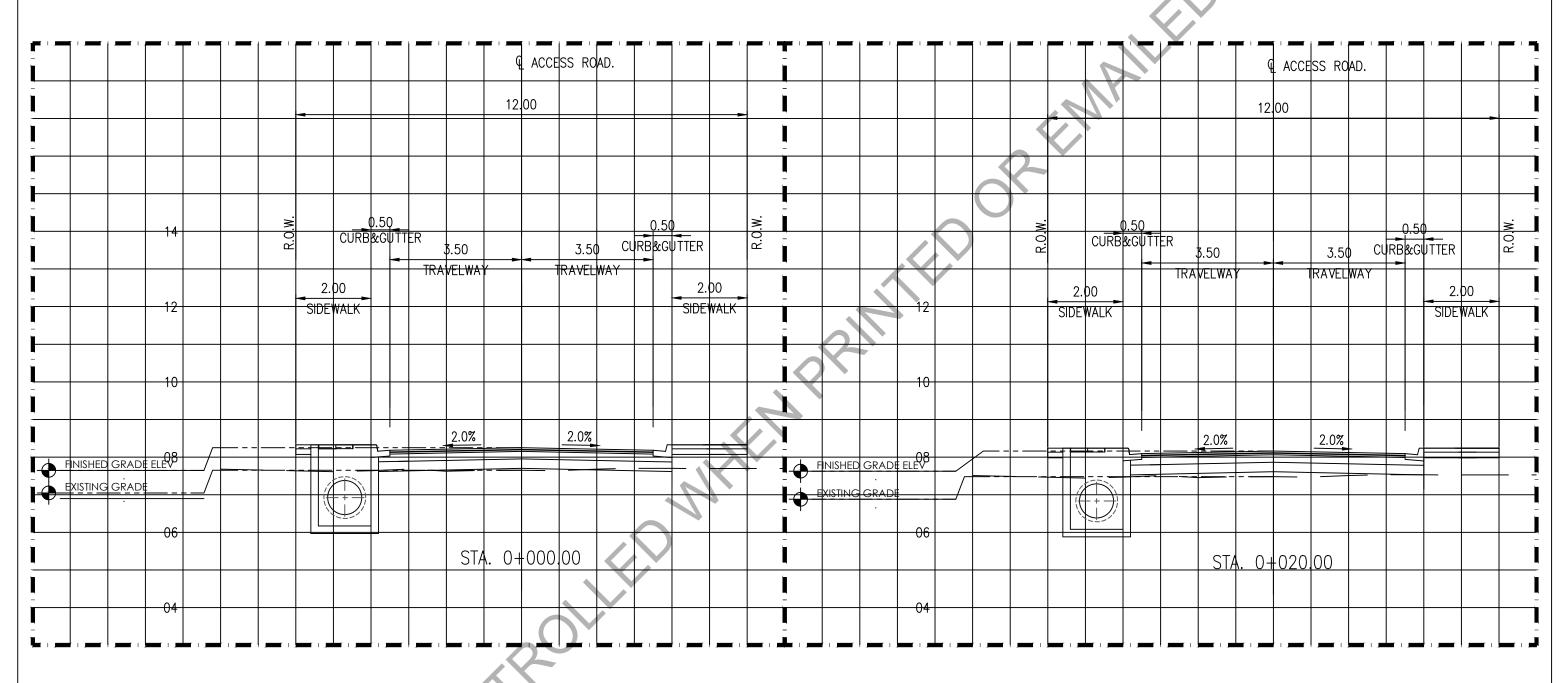


A TYPICAL CROSS SECTION (@ 0+000.00)

SCALE 1:100

B TYPICAL CROSS SECTION (@ 0+020.00)



PREPARED BY : PREPARED BY : PROJECT TITLE : SHEET CONTENT : SCALE: SHEET NO. TYPICAL CROSS SECTION DETAILS A-5.1 "STP, ACCESS ROAD AND FREEDOM PARK" JANSEN GABRIEL S. LIM ENGR. MARK P. TORRES OIC - ENGINEERING & SOCIAL SUPPORT DEPARTMENT DATE : DATE : LOCATION: PASONG TAMO EXTENSION, TAGUIG CITY REVISION NO.

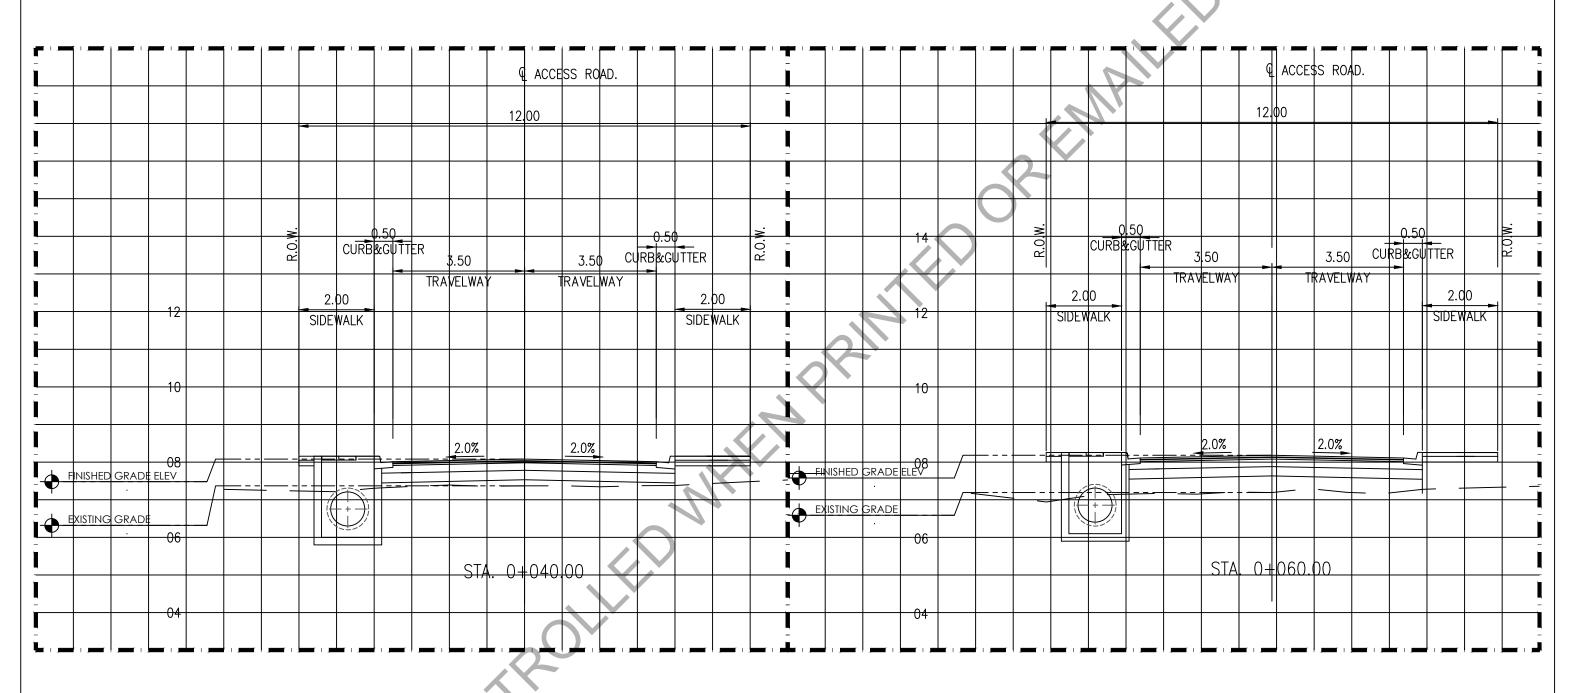

C TYPICAL CROSS SECTION (@ 0+040.00)
SCALE 1:100


TYPICAL CROSS SECTION (@ 0+060.00)

SHEET NO.

A-5.2



PREPARED BY : PROJECT TITLE : PREPARED BY : APPROVED AND REVIEWED B SHEET CONTENT : SCALE: TYPICAL CROSS SECTION DETAILS "STP, ACCESS ROAD AND FREEDOM PARK" JANSEN GABRIEL S. LIM JOHN V PACETE ENGR. MARK P. TORRES ENGINEER OIC - ENGINEERING & SOCIAL SUPPORT DEPARTMENT DATE : DATE : LOCATION: PASONG TAMO EXTENSION, TAGUIG CITY REVISION NO.

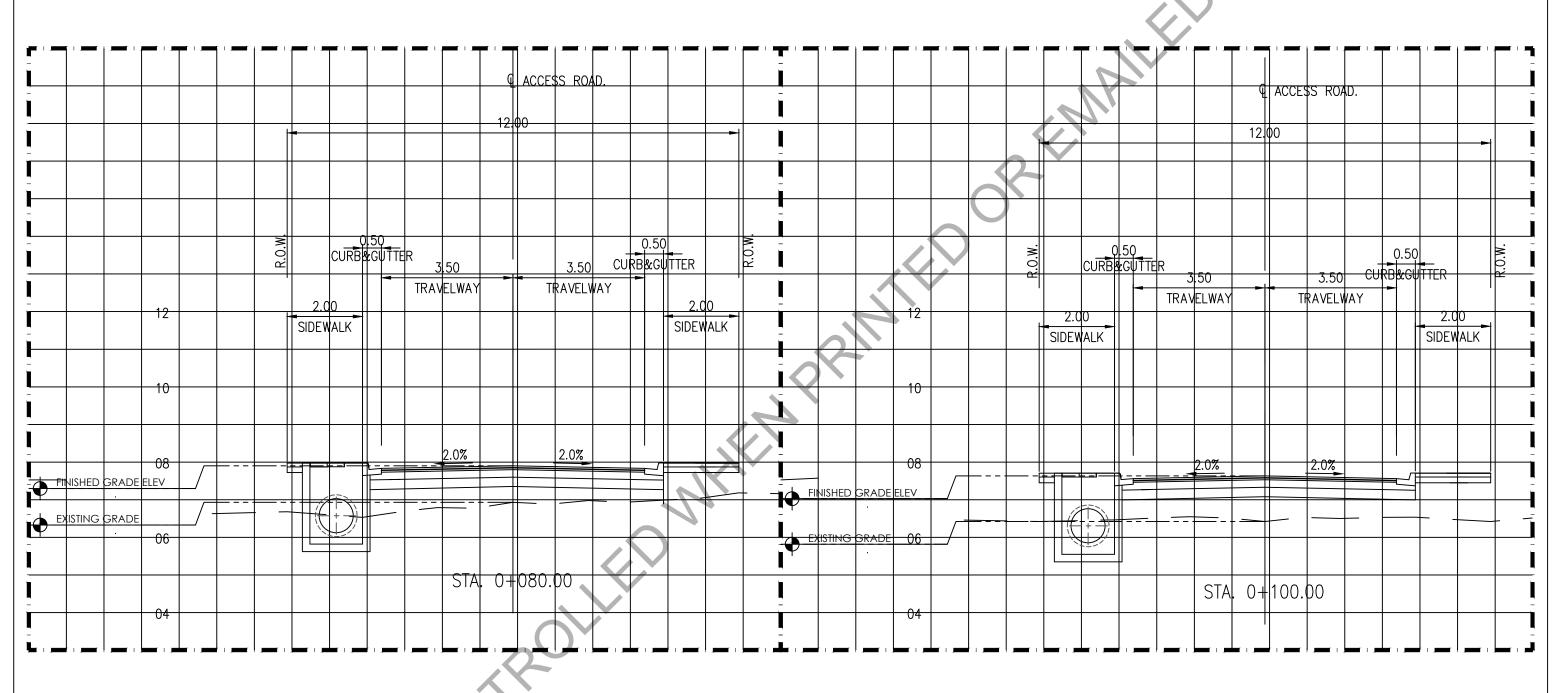

E TYPICAL CROSS SECTION (@ 0+080.00)

F TYPICAL CROSS SECTION (@ 0+100.00)

SCALE:

REVISION NO.

SHEET NO.

A-5.3



PREPARED BY:

APPROVED AND REVIEWS BY:

PROJECT TITLE:

SHEET CONTENT:

TYPICAL CROSS SECTION DETAILS

TYPICAL CROSS SECTION DETAILS


OIC - ENGINEER DATE:

DATE:

LOCATION: PASONG TAMO EXTENSION, TAGUIG CITY

SHEET CONTENT:

TYPICAL CROSS SECTION DETAILS

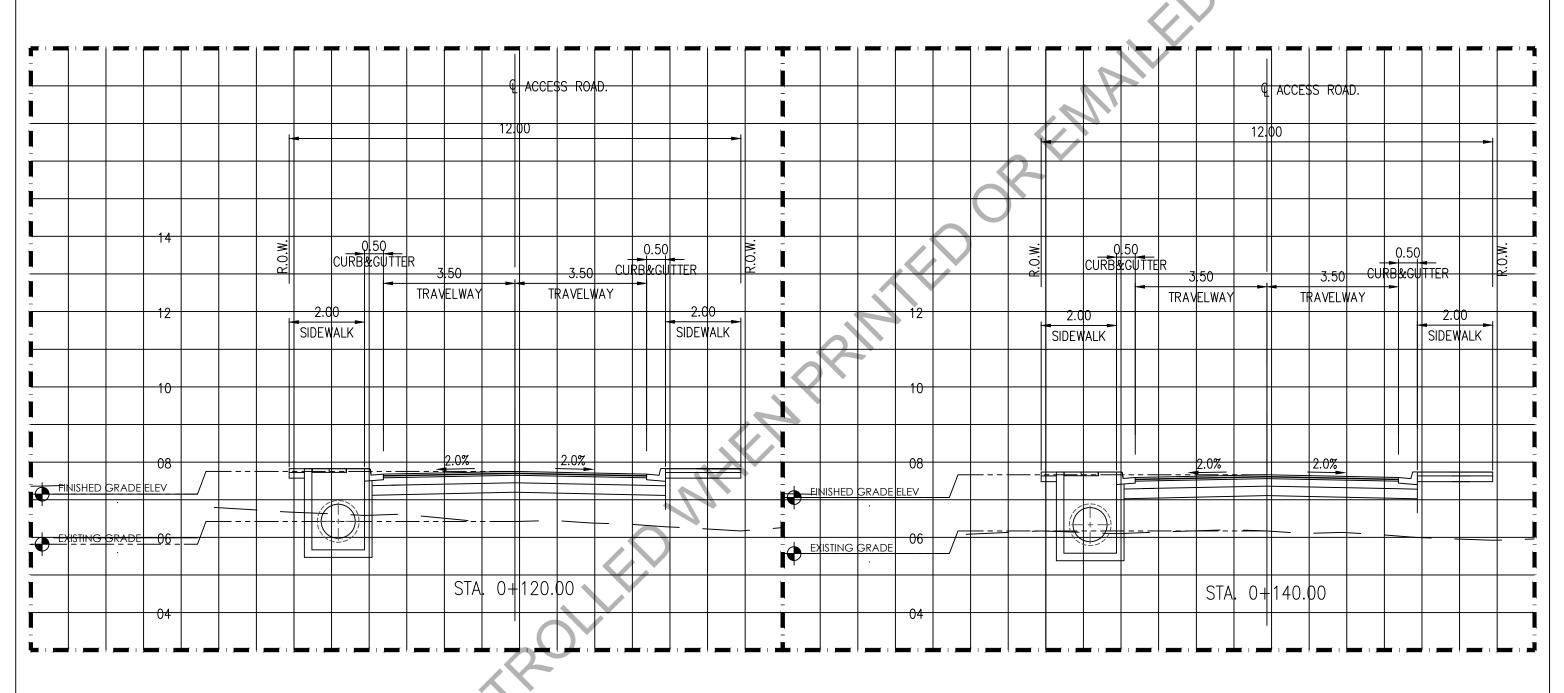


G TYPICAL CROSS SECTION (@ 0+120.00)

SCALE 1:100

H TYPICAL CROSS SECTION (@ 0+140.00)



PREPARED BY : PREPARED BY : APPROVED AND REVIEWED BY : PROJECT TITLE : SHEET CONTENT : SCALE: SHEET NO. TYPICAL CROSS SECTION DETAILS A-5.4 "STP, ACCESS ROAD AND FREEDOM PARK" JANSEN GABRIEL S. LIM ENGR. MARK P. TORRES OIC - ENGINEERING & SOCIAL SUPPORT DEPARTMENT DATE : LOCATION: PASONG TAMO EXTENSION, TAGUIG CITY REVISION NO.

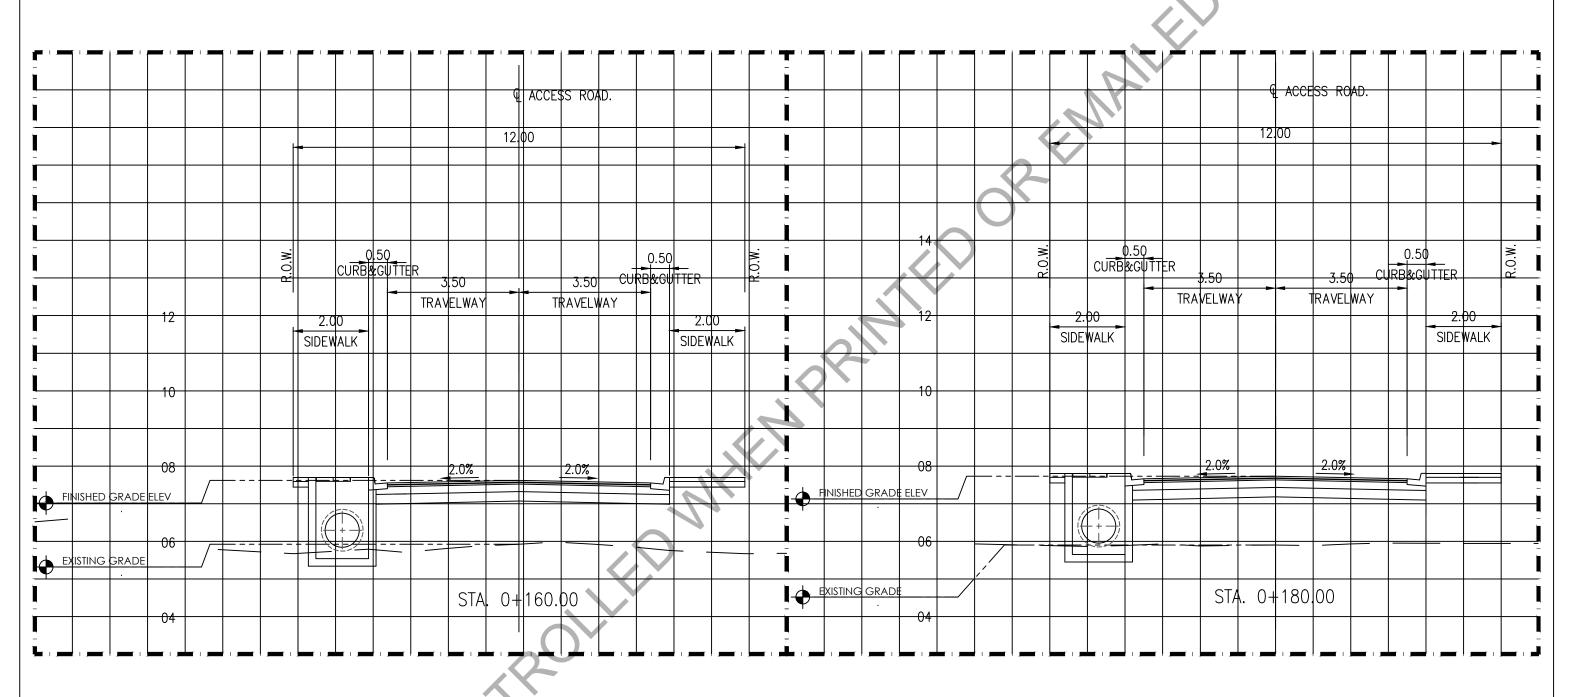

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SCALE 1:100


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SHEET NO.

A-5.5




PREPARED BY :	PREPARED BY:	APPROVED AND REVIEWED BY :	PROJECT TITLE :	SHEET CONTENT:	
JANSEN GABRIEL S. LIM ENGINEER	JOHN PACETE ARCHITECT	ENGR. MARK P. TORRES OIC - ENGINEERING & SOCIAL SUPPORT DEPARTMENT	"STP, ACCESS ROAD AND FREEDOM PARK"	TYPICAL CROSS SECTION DETAILS	
DATE:	DATE:	DATE:	LOCATION: PASONG TAMO EXTENSION, TAGUIG CITY		

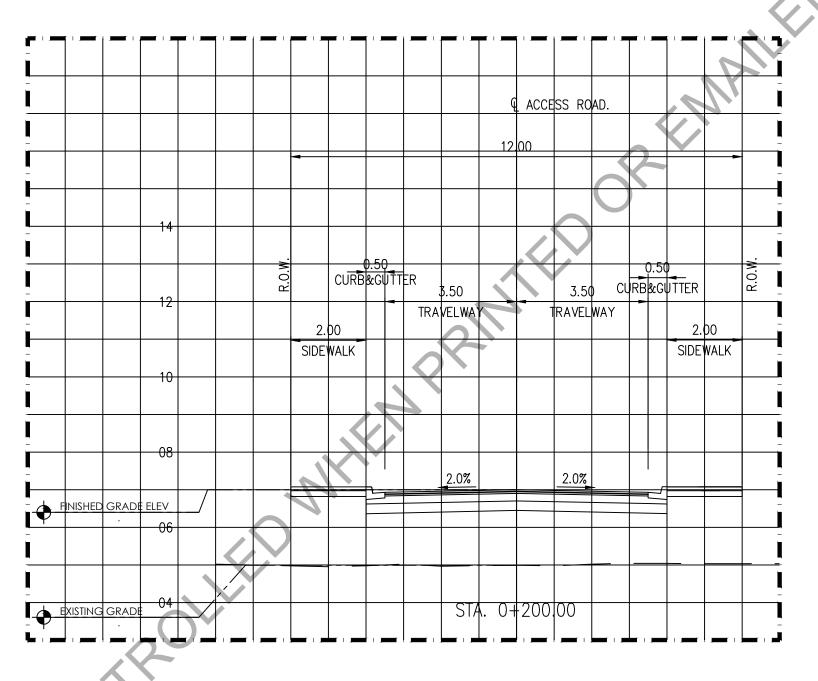


TYPICAL CROSS SECTION (@ 0+200.00)



	PREPARED BY :	PREPARED BY :	APPROVED AND REVIEWED BY :	PROJECT TITLE:	SHEET CONTENT:	SCALE :	SHEET NO.
•	JANSEN GABRIEL S. LIM ENGINEER	JOHN V BACETE ARCHITECT	ENGR. MARK P. TORRES OIC - ENGINEERING & SOCIAL SUPPORT DEPARTMENT	"STP, ACCESS ROAD AND FREEDOM PARK"	TYPICAL CROSS SECTION DETAILS	1:100	A-5.6
	DATE:	DATE:	DATE:	LOCATION: PASONG TAMO EXTENSION, TAGUIG CITY		REVISION N	NO.

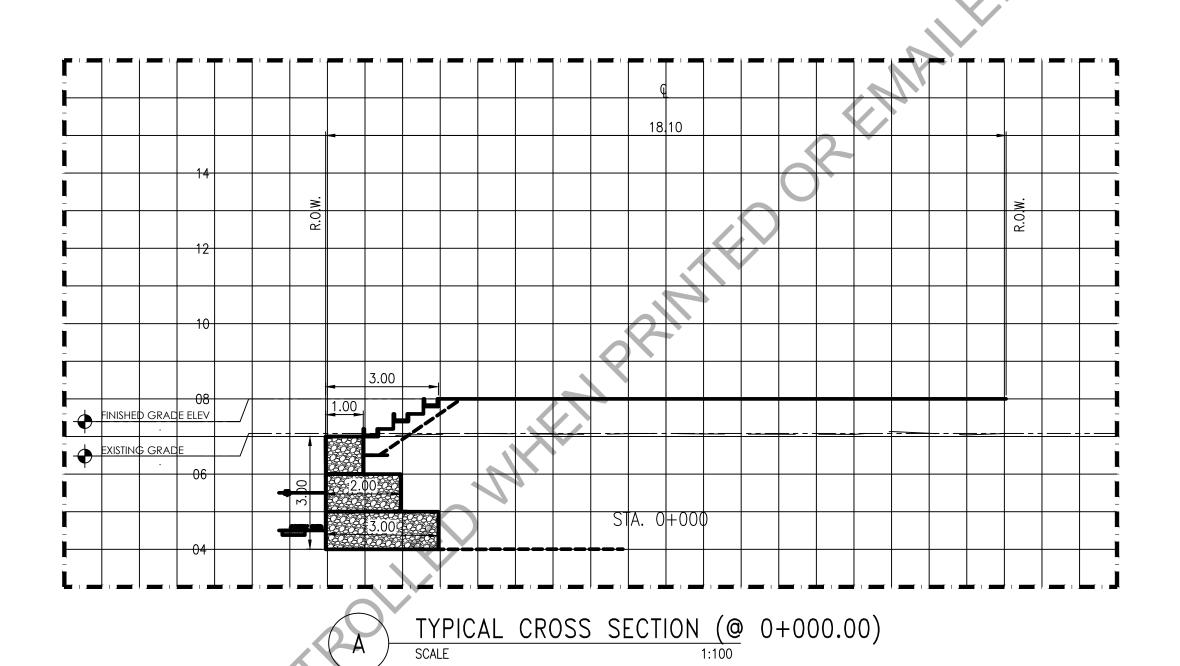

PREPARED BY : PREPARED BY : APPROVED AND REVIEWED E PROJECT TITLE : SHEET CONTENT: SHEET NO. 1:1000 TYPICAL CROSS SECTION DETAIL JANSEN GABRIEL S. LIM A-6 "STP, ACCESS ROAD AND FREEDOM PARK" JOHN V PACETE ENGR. MARK P. TORRES OIC - ENCINEERING & SOCIAL SUPPORT DEPARTMENT DATE : DATE : LOCATION: PASONG TAMO EXTENSION, TAGUIG CITY REVISION NO.

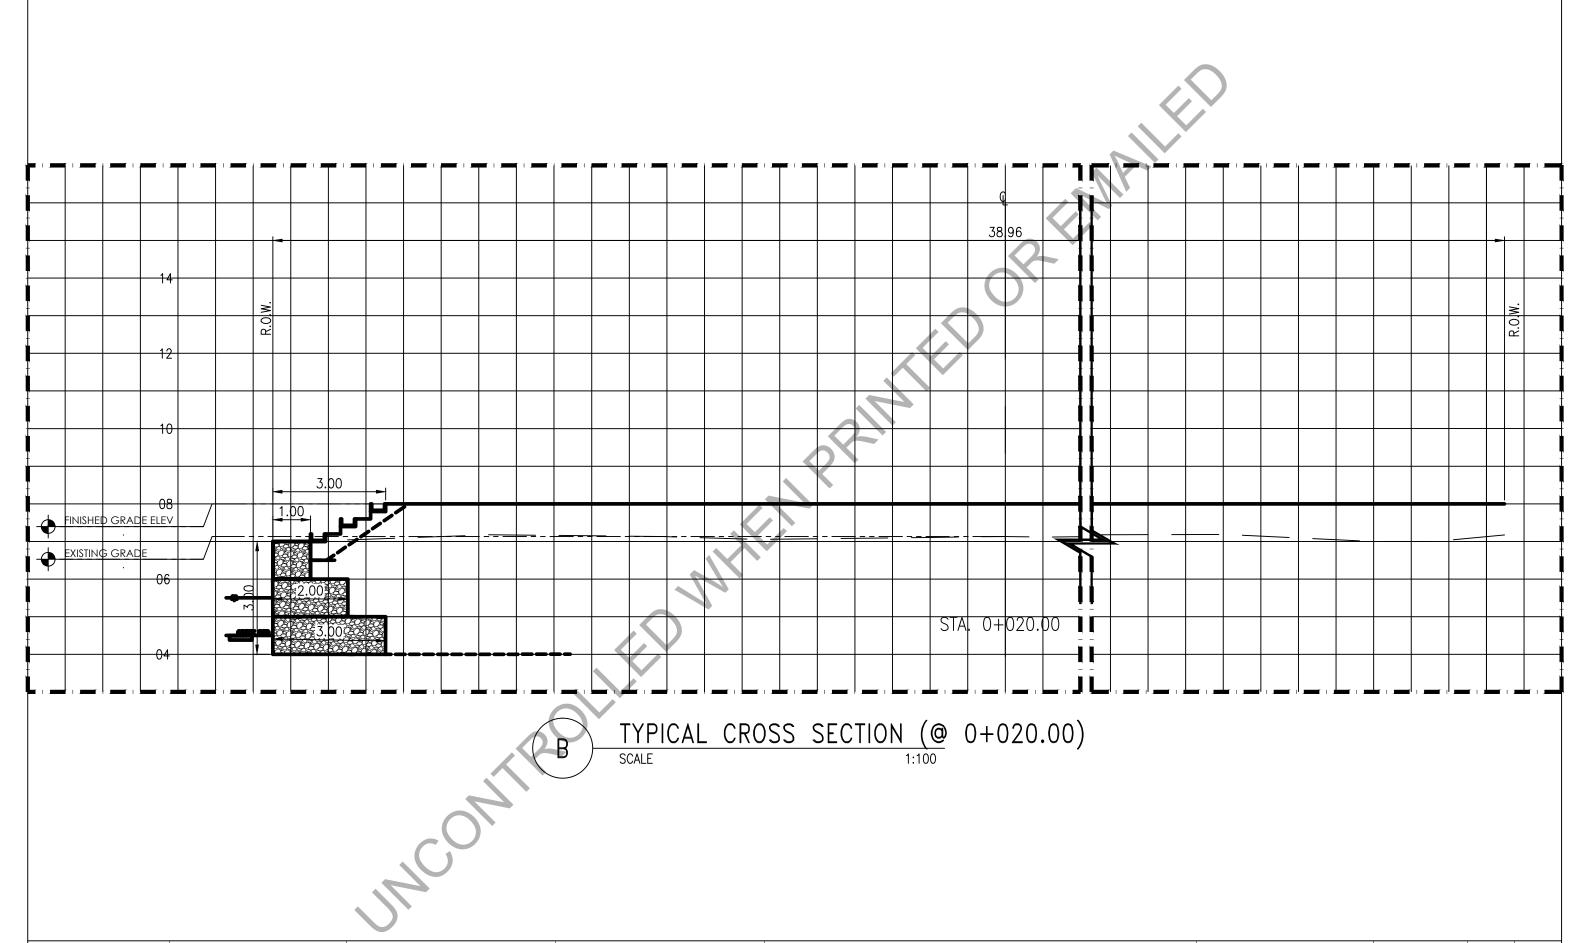

PREPARED BY:

PREPARED BY:

APPROVED AND REVIEWED BY:

APPROVED AND REVIEWED BY:

ENGR. MARK P. TORRES

OIC - ENGINEERING & SOCIAL SUPPORT DEPARTMENT

DATE:

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TYPICAL CROSS SECTION DETAIL

"STP, ACCESS ROAD AND FREEDOM PARK"


LOCATION: PASONG TAMO EXTENSION, TAGUIG CITY

SCALE: SHEET NO.

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REVISION NO.



PREPARED BY:

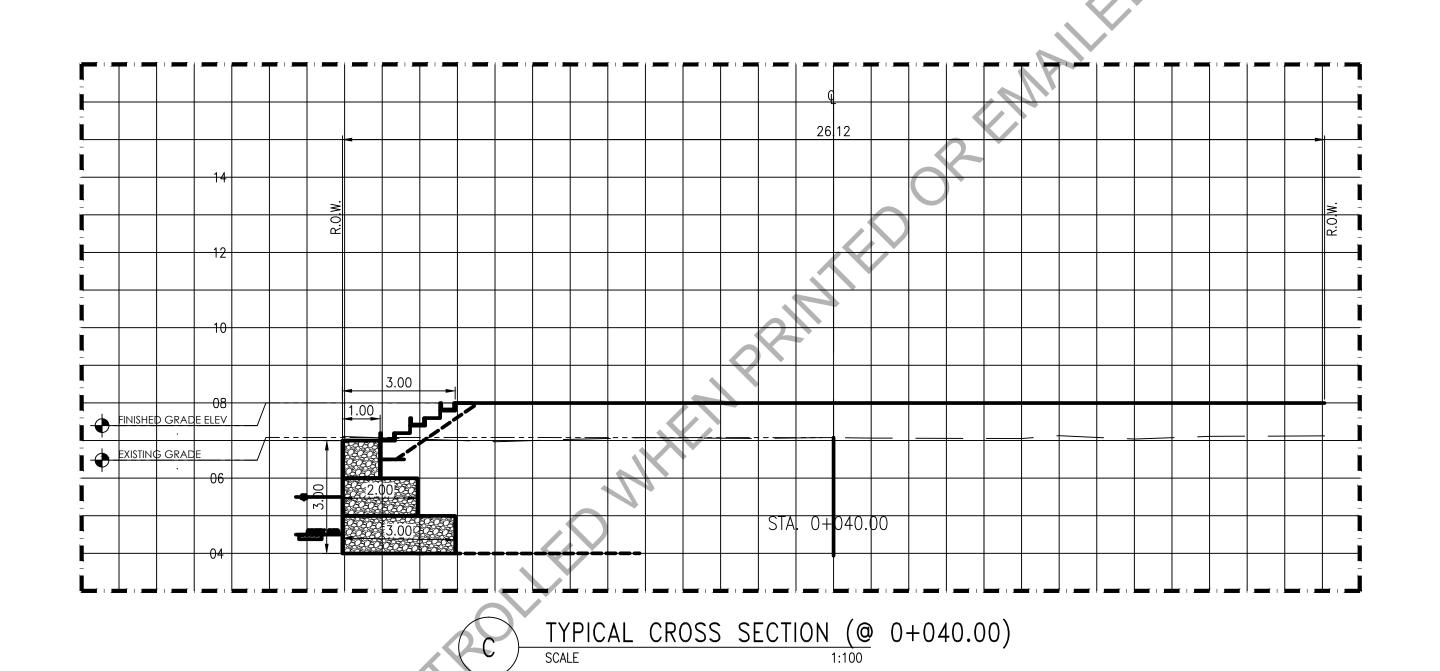APPROVED AND REVIEWED BY:

PROJECT TITLE:

SHEET CONTENT:

TYPICAL CROSS SECTION DETAIL

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OIC - ENGINEER DATE:


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LOCATION: PASONG TAMO EXTENSION, TAGUIG CITY

SHEET NO.

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PROJECT TITLE :


LOCATION: PASONG TAMO EXTENSION, TAGUIG CITY

PREPARED BY :

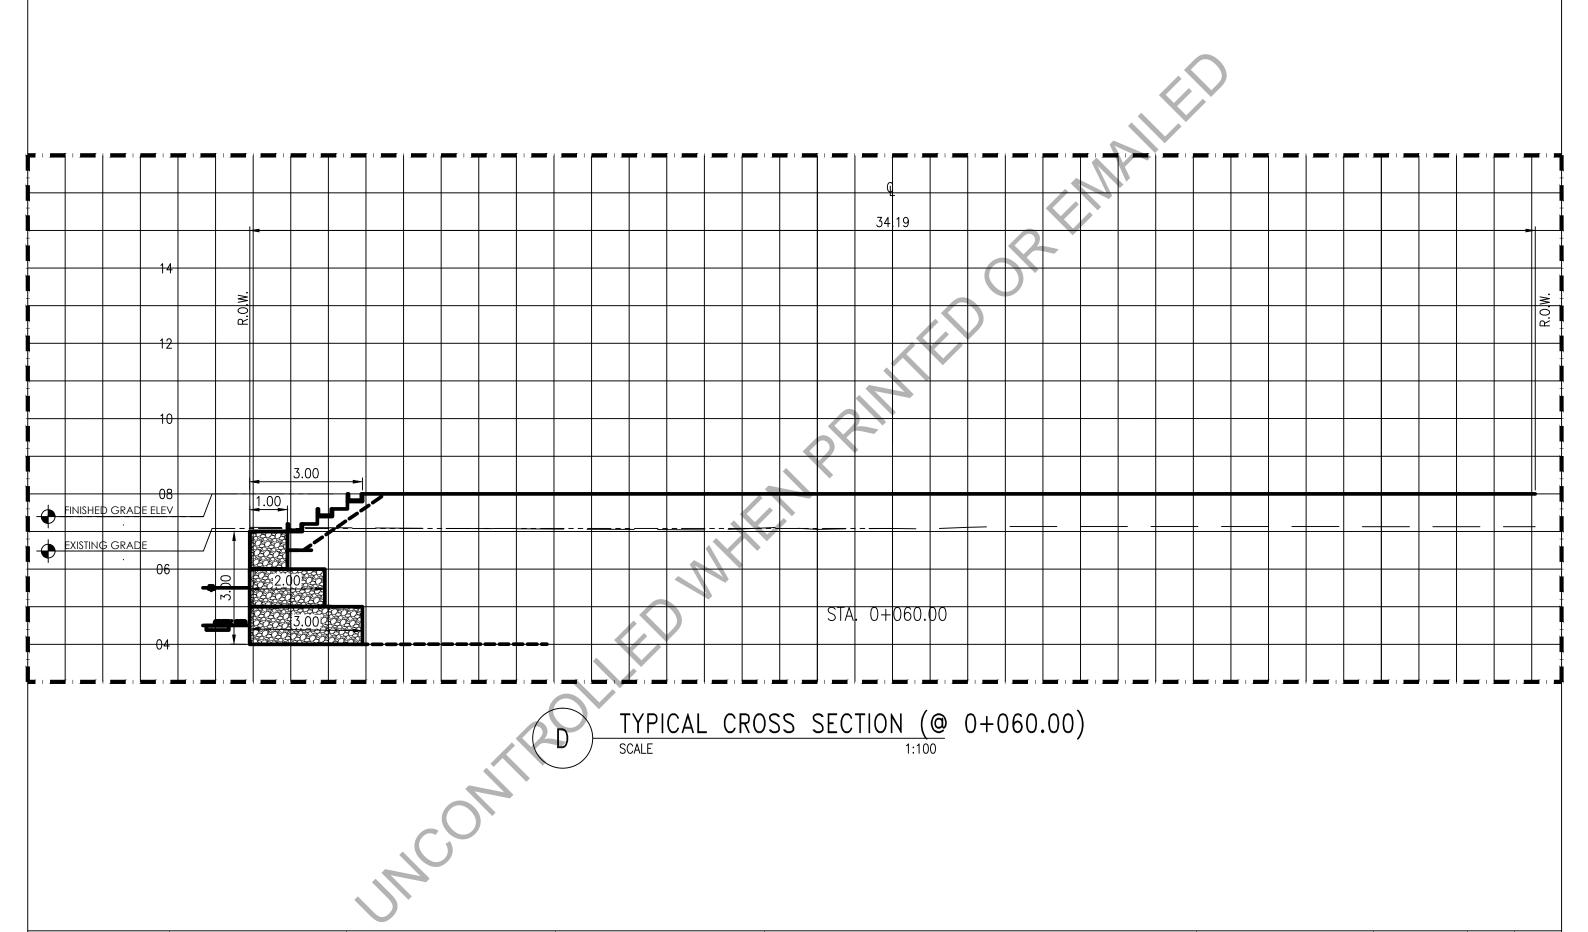PREPARED BY : APPROVED AND REVIEWED BY JANSEN GABRIEL S. LIM ENGR. MARK P. TORRES OIC - ENGINEERING & SOCIAL SUPPORT DEPARTMENT DATE :

SHEET CONTENT: TYPICAL CROSS SECTION DETAIL "STP, ACCESS ROAD AND FREEDOM PARK"

SHEET NO. A-6.3 REVISION NO.

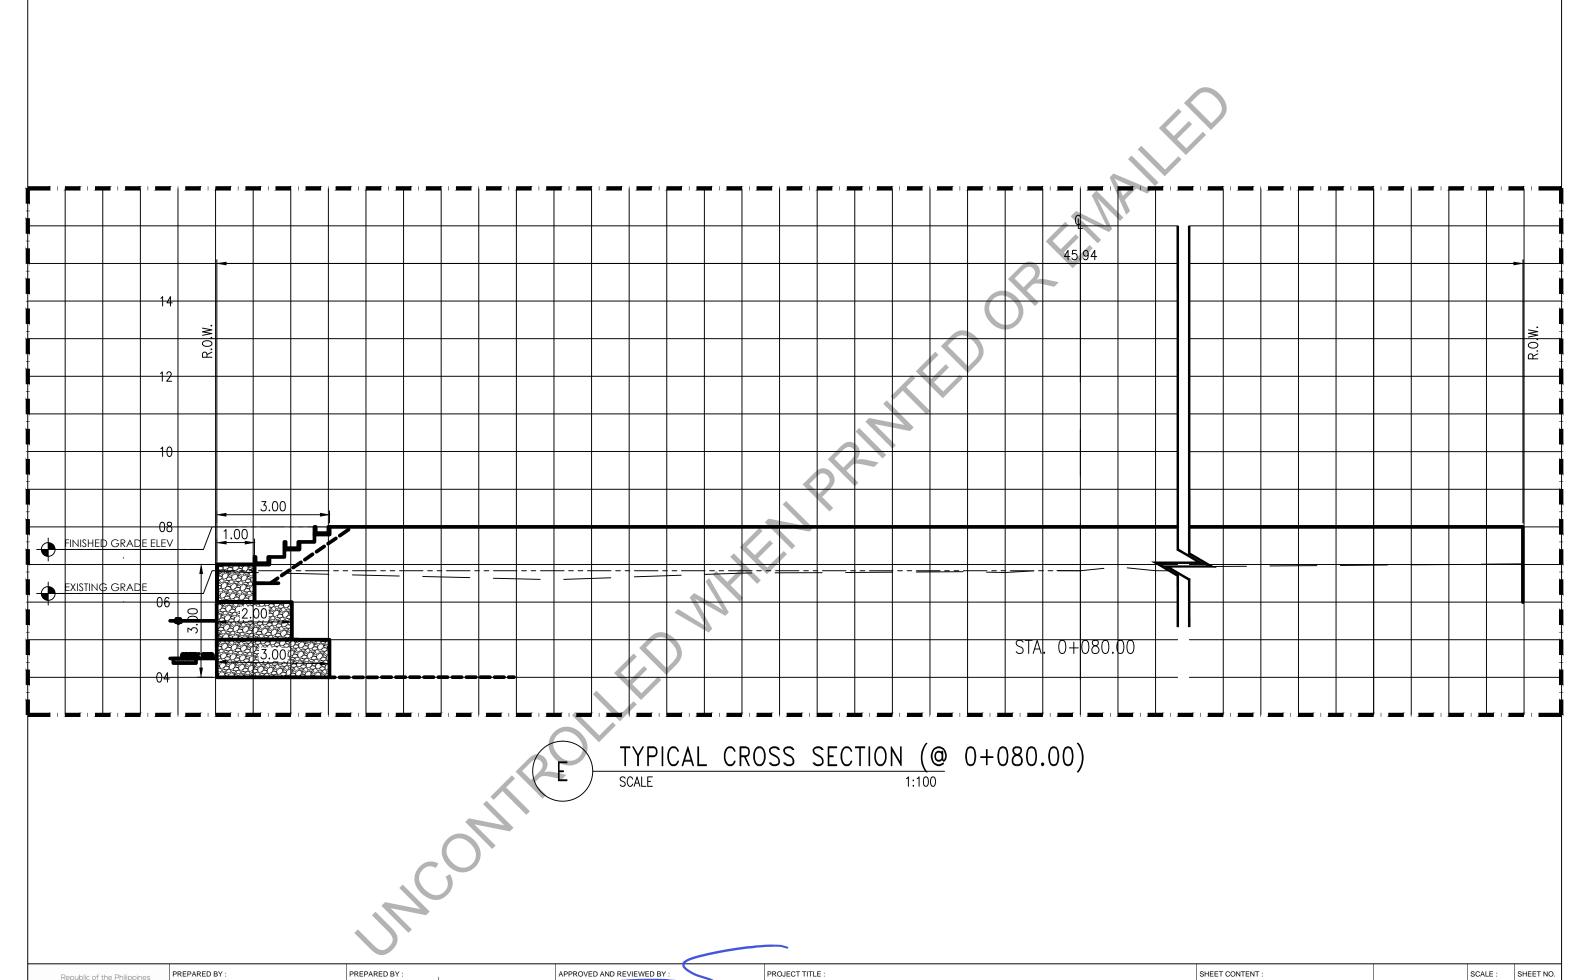

JANSEN GABRIEL S. LIM

ENGINEER

DATE:

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JOHN PACETE
OIC - ENGINED MARK P. TORKES
OIC - ENGINED MARK SOCIAL SUPPORT DEPARTMENT
DATE:

"STP, ACCESS ROAD AND FREEDOM PARK"


LOCATION: PASONG TAMO EXTENSION, TAGUIG CITY

SCALE: SHEET NO.

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REVISION NO.



PREPARED BY:

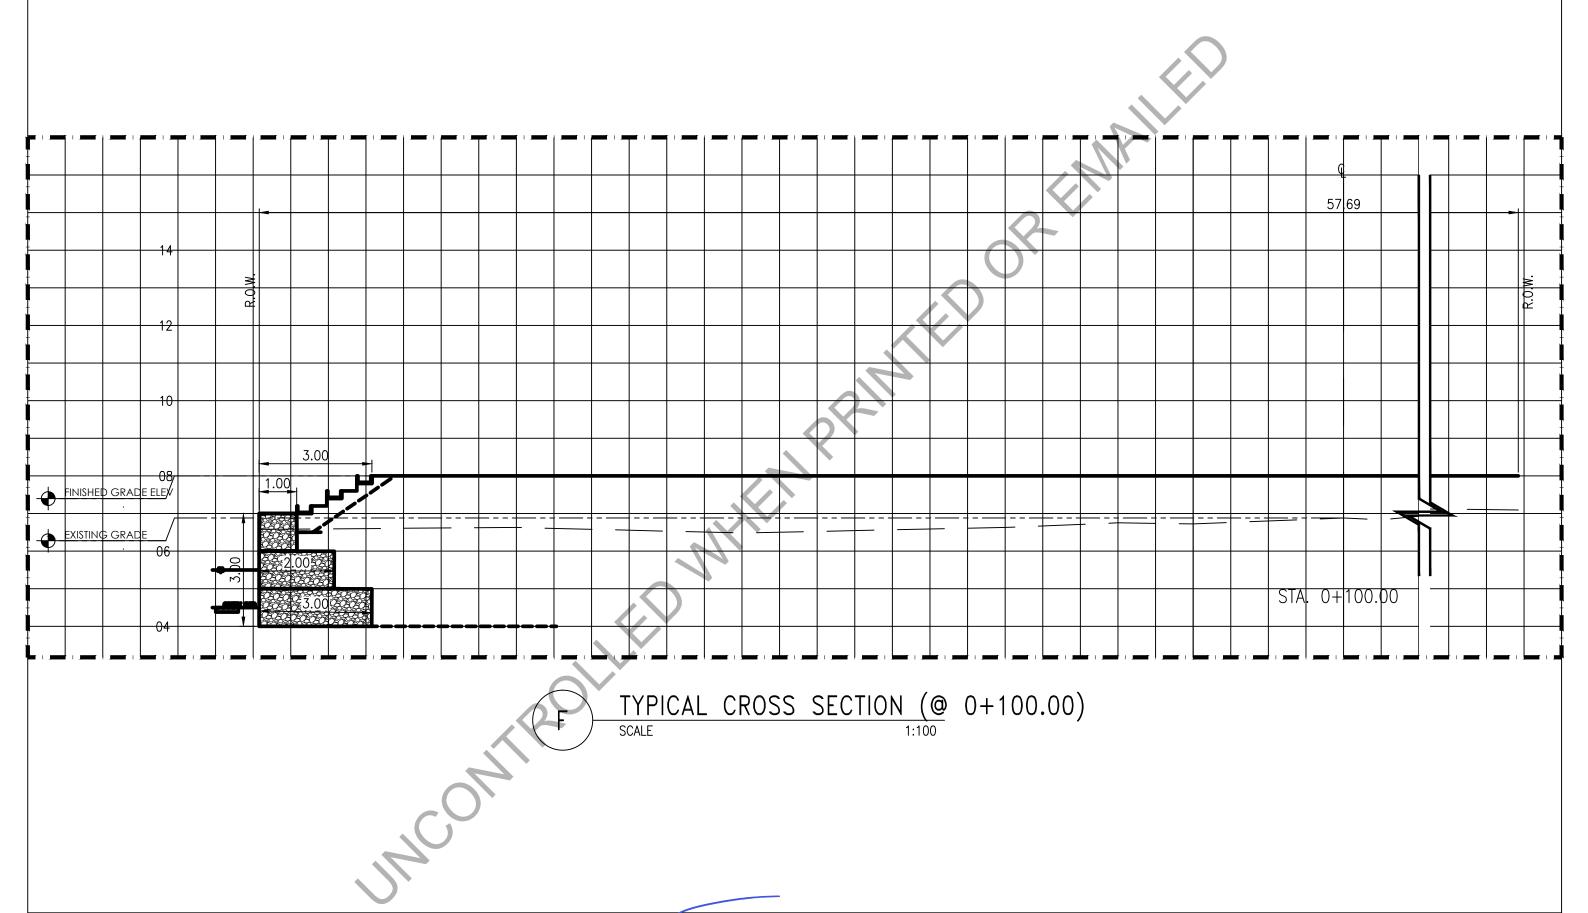APPROVED AND REMEWED BY:

JANSEN GABRIEL S. LIM

ENGINEER

DATE:

APPROVED AND REMEWED BY:

APPROVED AND REMEWED BY:

ENGR. MARK P. TORRES

OIC ENGINEERING & SOCIAL SUPPORT DEPARTMENT

DATE:

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PROJECT TITLE:

"STP, ACCESS ROAD AND FREEDOM PARK"

LOCATION: PASONG TAMO EXTENSION, TAGUIG CITY

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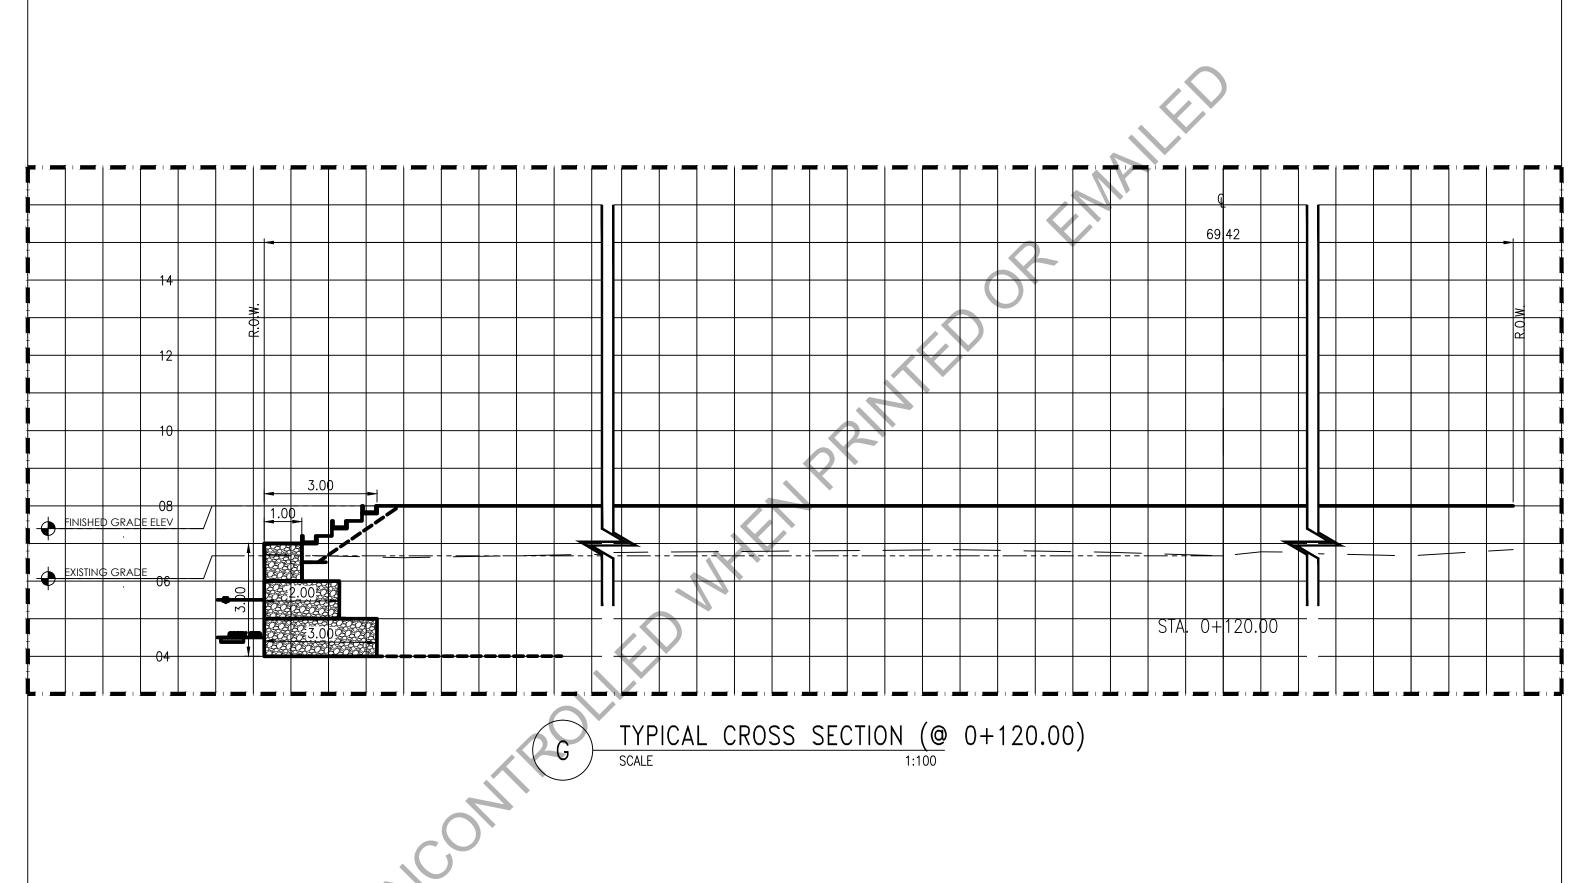
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REVISION NO.



PREPARED BY:

APPROVED AND REVIEWED BY:


PROJECT TITLE:

STP, ACCESS ROAD AND FREEDOM PARK"

OIC - ENGINEERING & SOCIAL SUPPORT DEPARTMENT


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SHEET CONTENT:

TYPICAL CROSS SECTION DETAIL

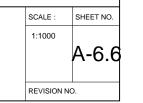

JANSEN GABRIEL S. LIM

ENGINEER

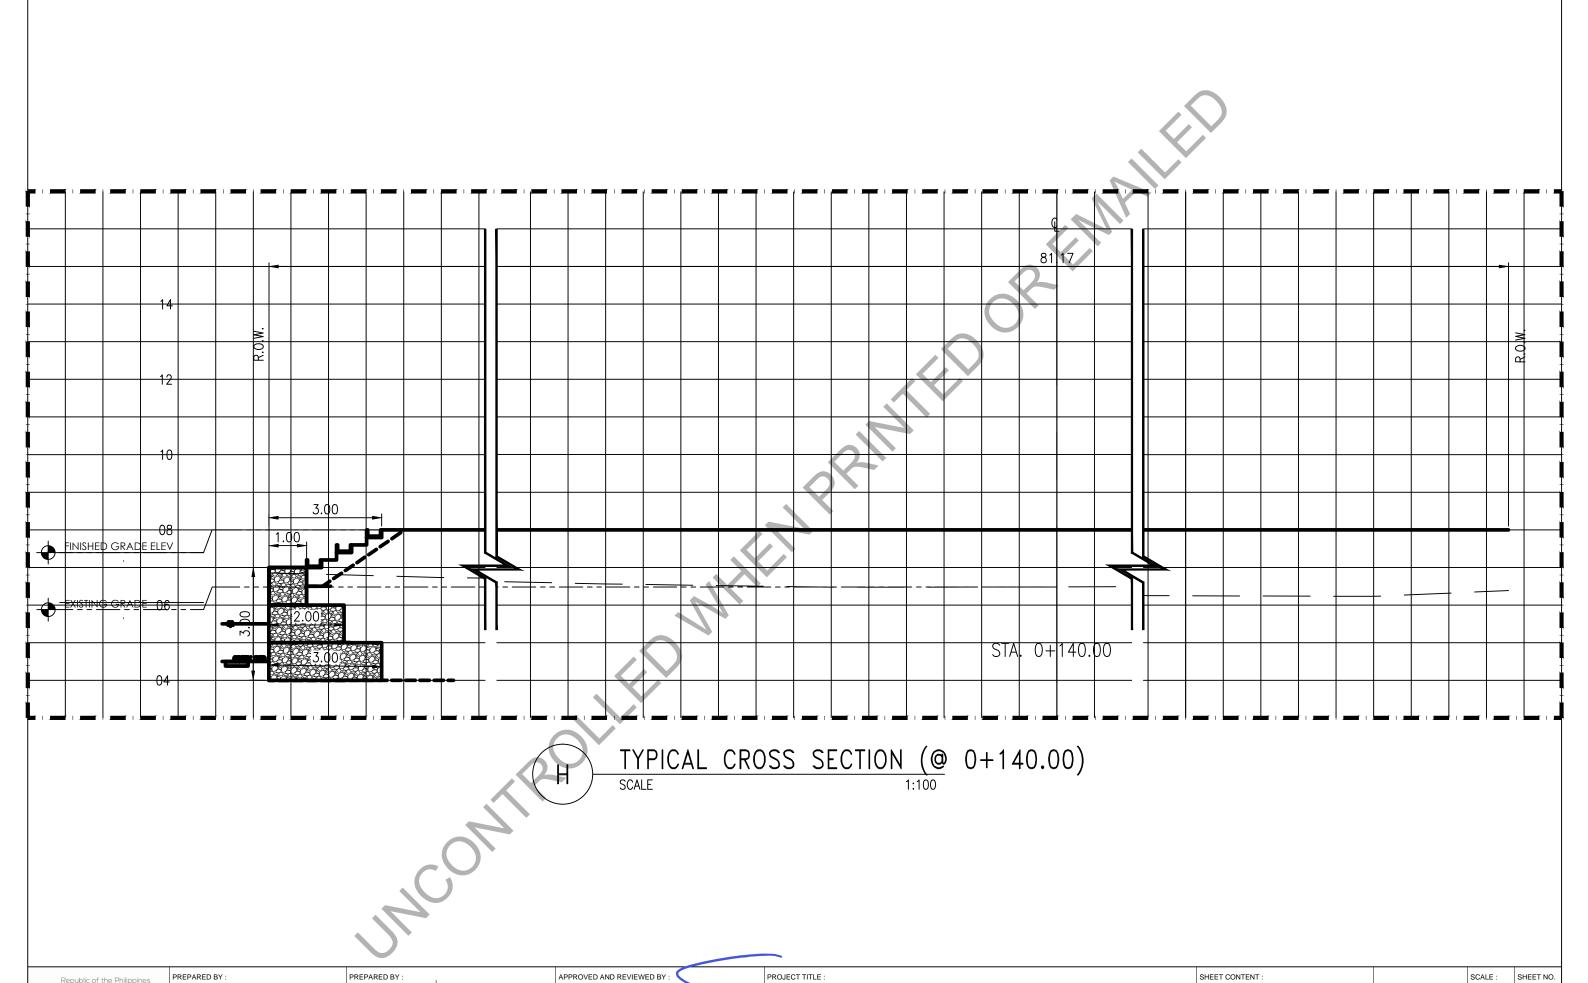DATE:

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ENGR. MARK P. TORKES

OIC - ENGINEERING & SOCIAL SUPPORT DEPARTMENT

DATE:

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"STP, ACCESS ROAD AND FREEDOM PARK"


LOCATION: PASONG TAMO EXTENSION, TAGUIG CITY

SCALE: SHEET NO.

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A-6.7

REVISION NO.

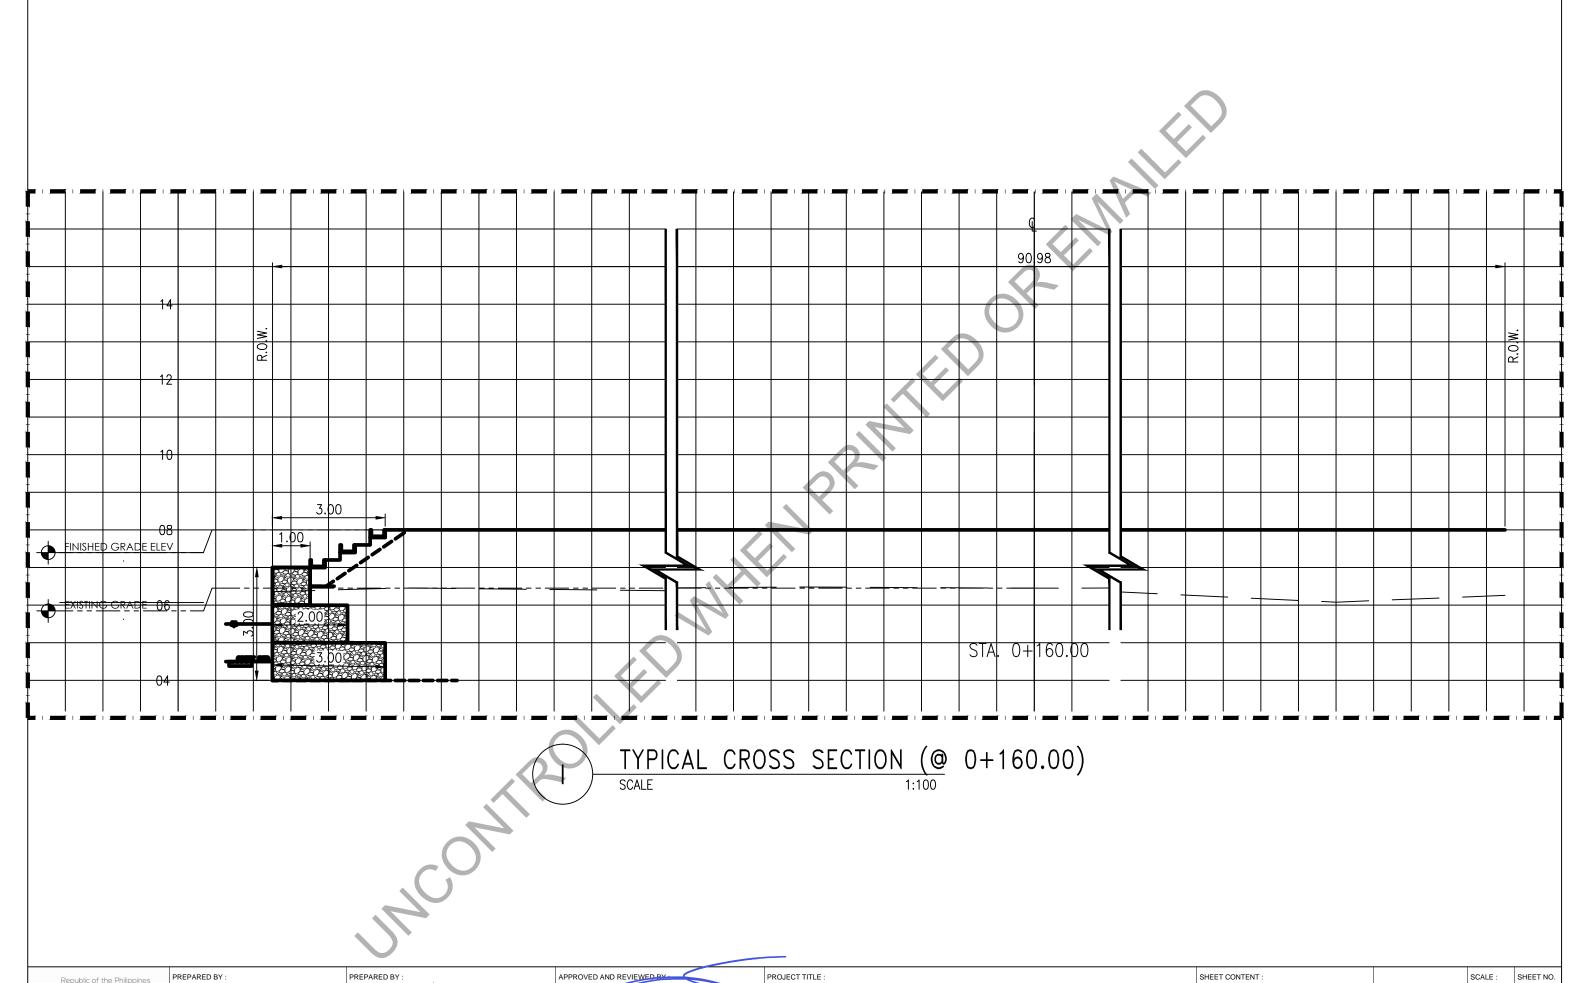

JANSEN GABRIEL S. LIM

ENGINEER

DATE:

PREPARED BY:

APPROVED AND REVIEWED BY:

APPROVED AND REVIEWED BY:

ENGR. MARK P. TORRES

OIC - ENGINEERING & SOCIAL SUPPORT DEPARTMENT

DATE:

"STP, ACCESS ROAD AND FREEDOM PARK"


LOCATION: PASONG TAMO EXTENSION, TAGUIG CITY

SCALE: SHEET NO.

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A-6.8

REVISION NO.

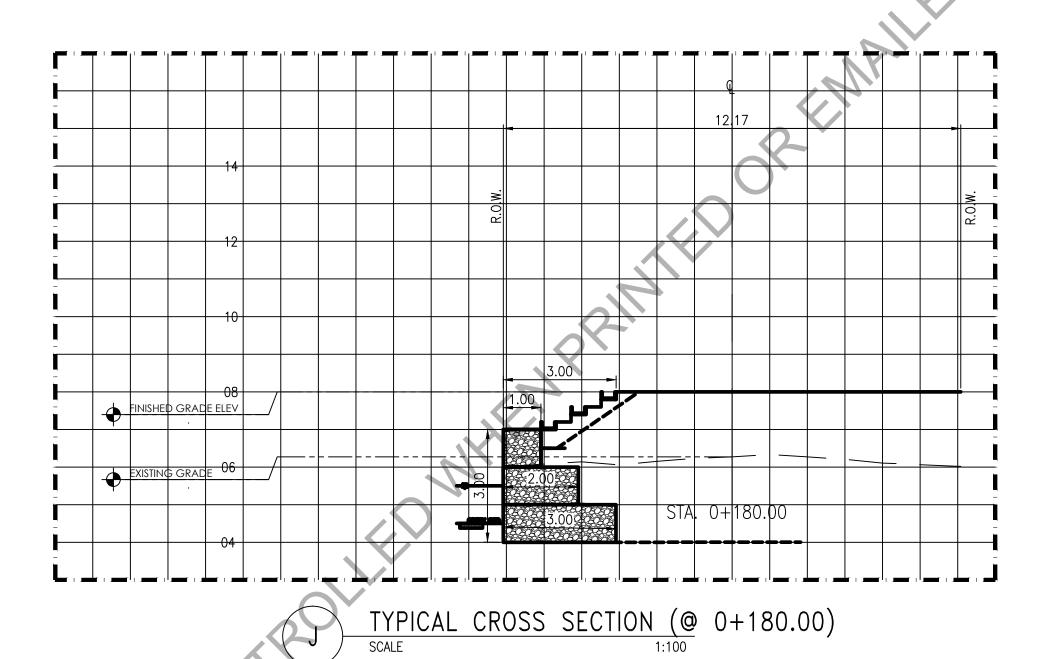

PREPARED BY:

APPROVED AND REVIEWED BY:

PROJECT TITLE:

SHEET CONTENT:

TYPICAL CROSS SECTION DETAIL

TYPICAL CROSS SECTION DETAIL

OIC - ENGINEERING & SOCIAL SUPPORT DEPARTMENT

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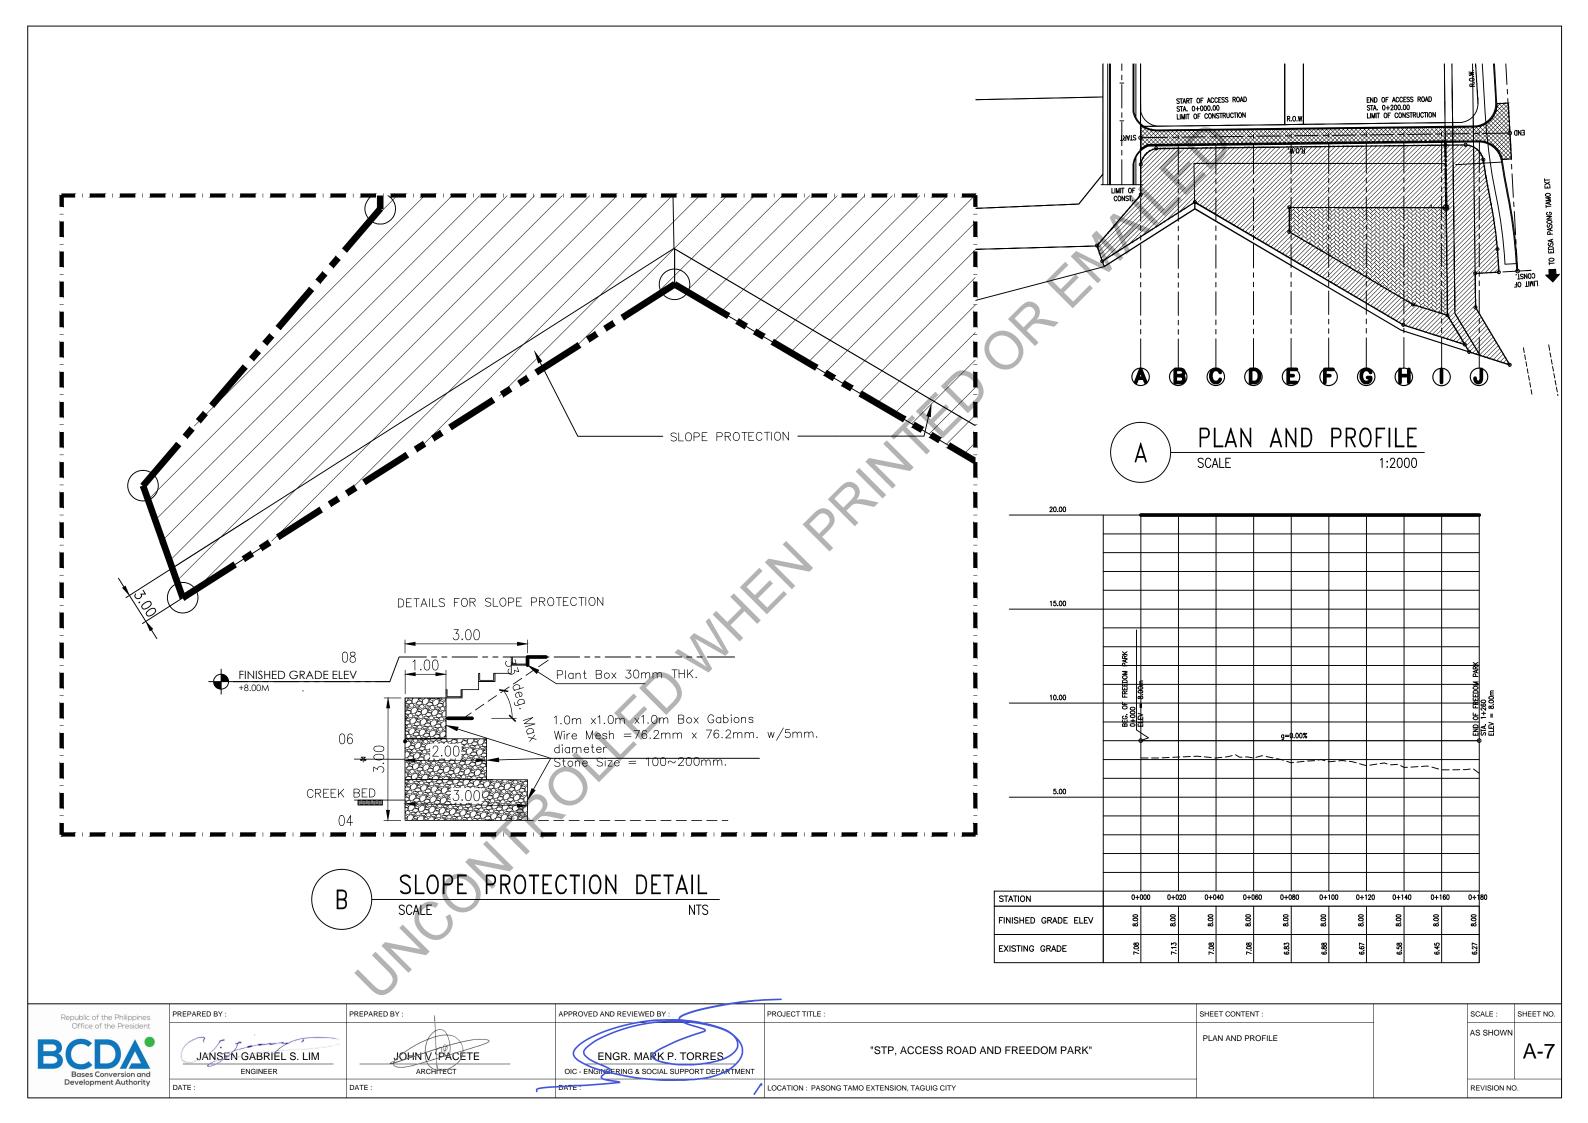
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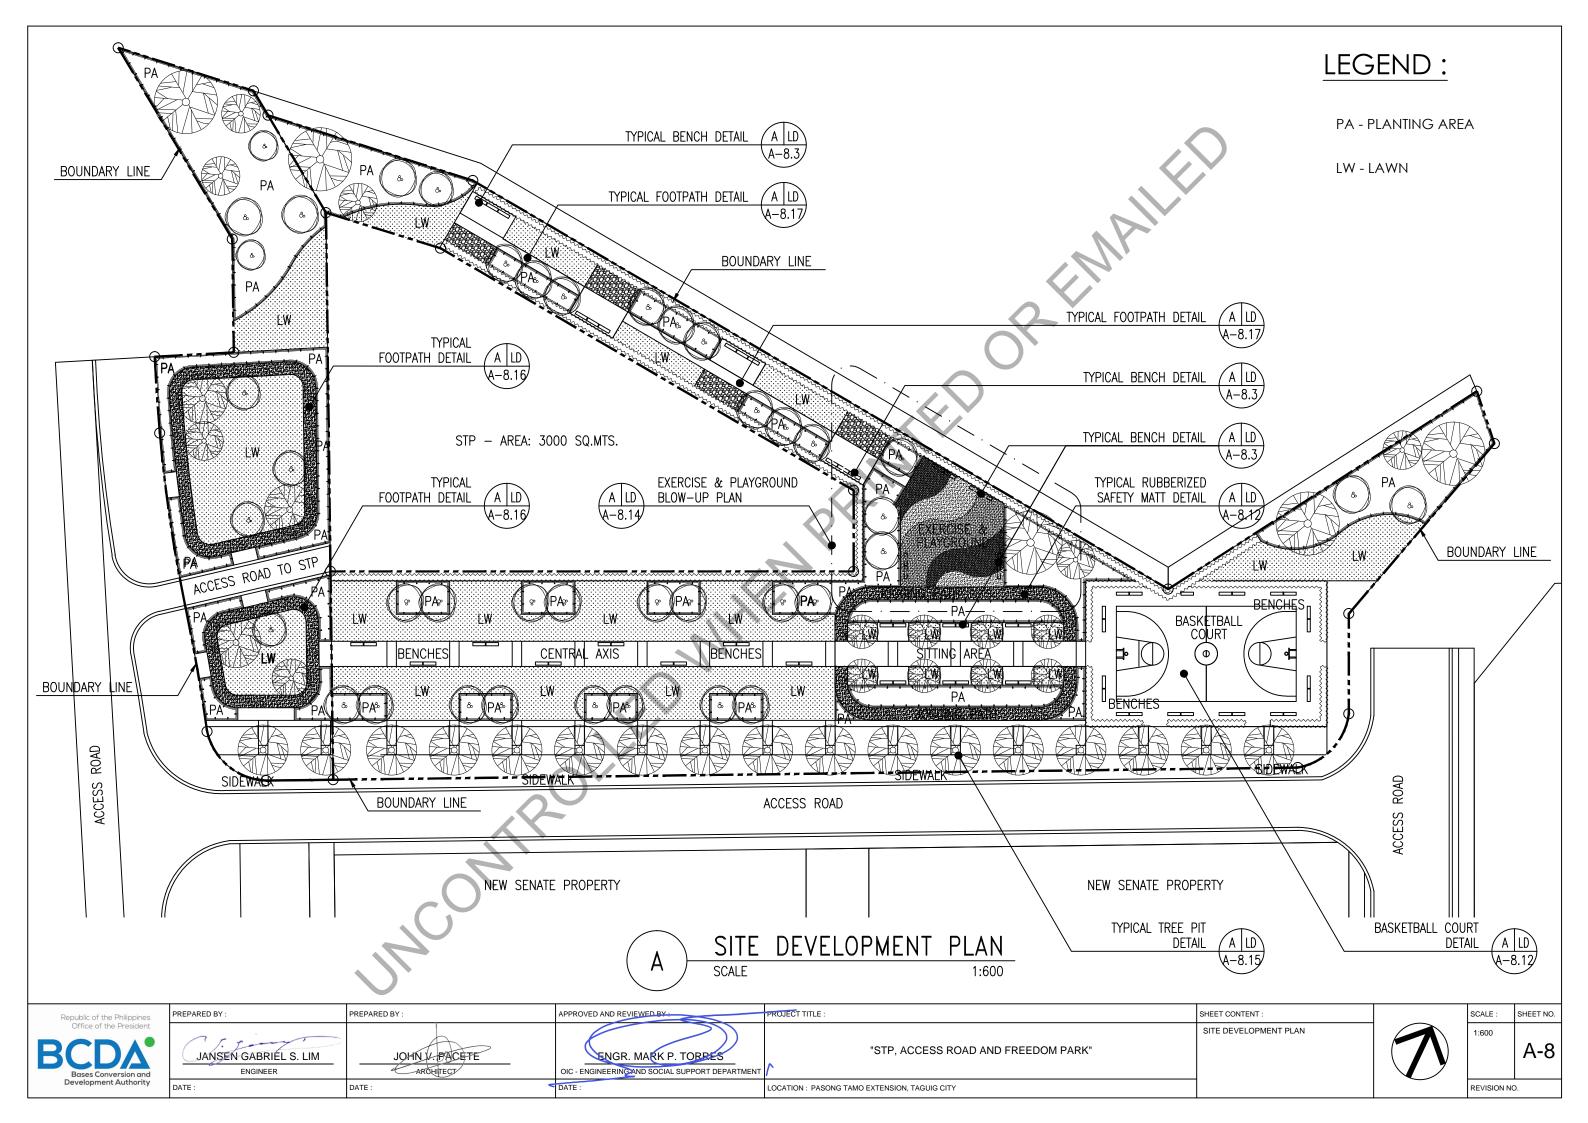
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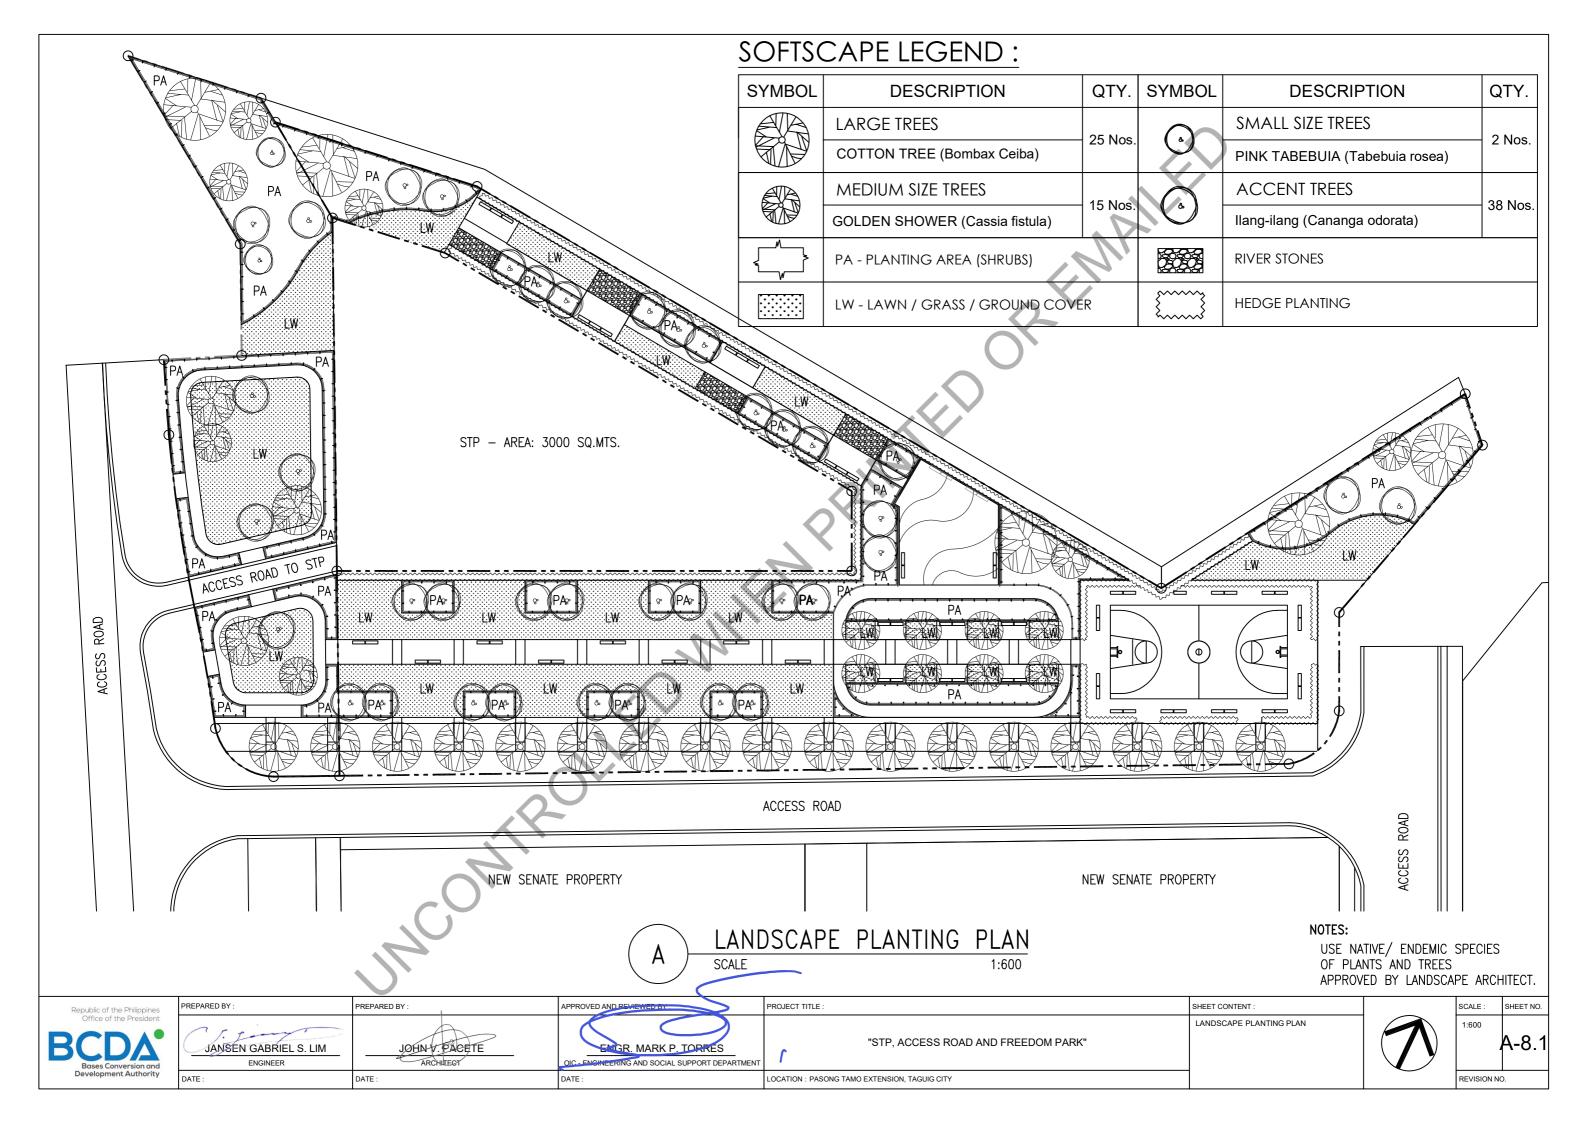
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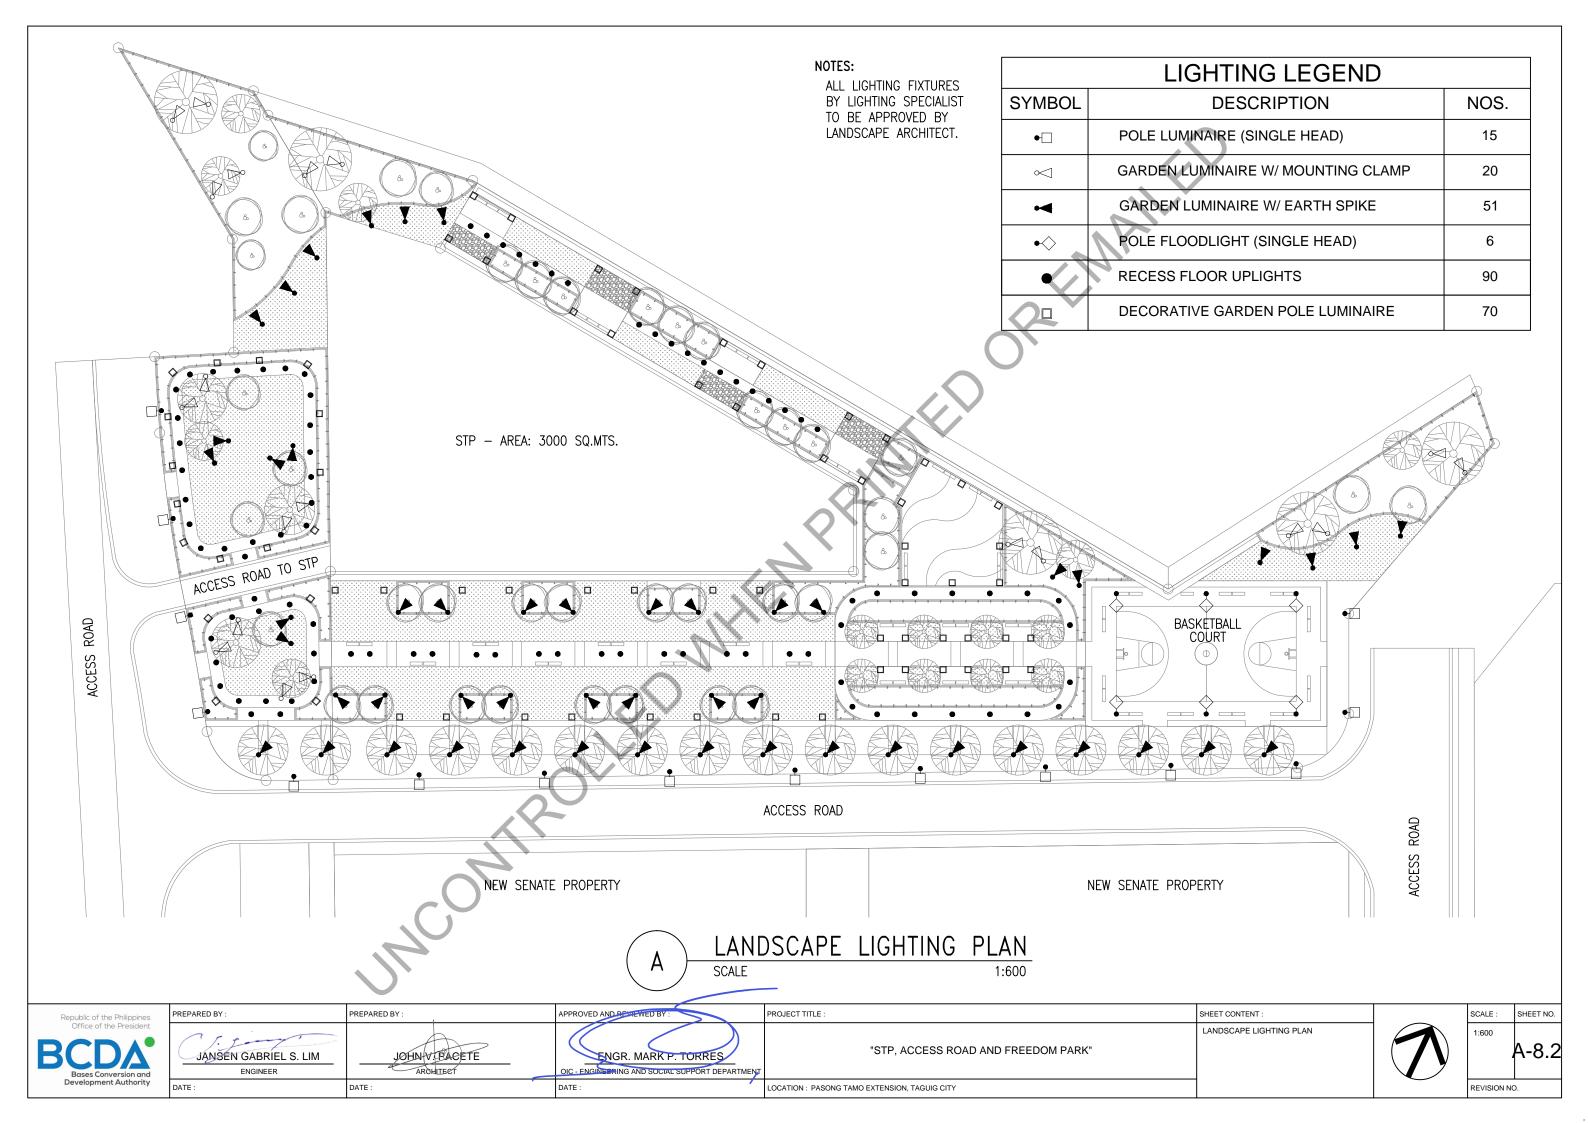
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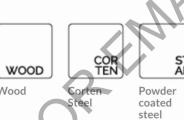








FINISHINGS AND MATERIAL



Elements 2.4m benches with medium side-to-side timber slats and powder coated corten-effect plate ends

PRODUCT CODES & OUTLINE SPECIFICATIONS:

STANDARD	YI.

People	Length mm	Width mm	Length mm	Width mm	Height mm
3 person	1830	510	1980	675	450
4 person	2430	510	2580	675	450

Please download and complete the Elements Enquiry form for your seating specification.

MATERIALS:

Create your own Elements seat and bench from the options below in four easy steps.

- 1. Iroko timber slat size (width): small 40mm, medium 65mm or large 140mm
- 2. Orientation of slats: side to side or back to front
- 3. Fascia boards: timber, stalpless steel 304 or 316 bright/satin polished, steel galvanised or powder coated
- 4. Plate ends supports: stainless steel 304 or 316 bright/satin polished, steel galvanised, corten steel or powder coated

INSTALLATION:

 All plate end seat supports are supplied pre-drilled for bolt-down installation with 2no. M10 or M12 fixings (not supplied)

A taller plate can be supplied to allow for bolting down below the finished ground level if









nes	PREPARED BY :	PREPARED BY :	APPROVED AND REVIEWED BY :	PROJECT TITLE :	SHEET CONTENT:	SCALE :	SHEET NO.	1
and	JANSEN GABRIEL S. LIM ENGINEER	JOHN VIBACETE ARCHITECT	ENGR. MARK P. TORRES OIC - ENGINEERING AND SOCIAL SUPPORT DEPARTMENT	"STP, ACCESS ROAD AND FREEDOM PARK"	TYPICAL BENCH DETAIL	NTS	A-8.3	
rity	DATE:	DATE:	DATE:	LOCATION : PASONG TAMO EXTENSION, TAGUIG CITY		REVISION	NO.	ı

NOTE:

Benches indicated are subject to availability and Landscape Architects recommendation.


SYMBOL	DESCRIPTION	NOS.
•	POLE LUMINAIRE (SINGLE HEAD)	15

NOTE: Lighting Fixtures indicated are subject to availability and Landscape Architects

recommendation.

SYMBOL	DESCRIPTION	NOS.
\bowtie	GARDEN LUMINAIRE W/ MOUNTING CLAMP	20

NOTE: Lighting Fixtures indicated are subject to availability and Landscape Architects recommendation.

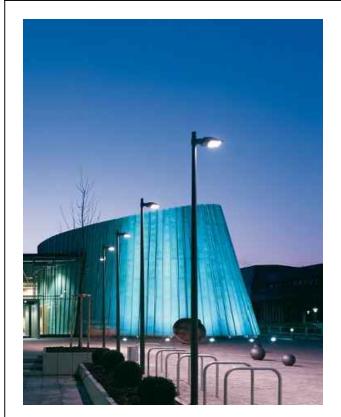

LED pole-top luminaires symmetrical or asymmetrical flat beam light distribution

Luminaires in different sizes, light outputs and two light distributions:

- With asymmetrical light distribution for providing spatial illumination of surfaces, squares and parking spaces, or
- · With asymmetrical flat beam light distribution for the illumination of driveways and streets

Using the adjustable attack angle of the luminaire housings, the light distribution can be adjusted exactly to the surface to be illuminated. Luminaires ready for installation, for single or double arrangements.







Long Cowl Mini-Accent Tree or Surface Light

Surface Light has an extra long cowl that allows for maximum light wash across a tree's surface. It is made out of durable die-cast aluminum and finished in a rich Textured Architectural Bronze. Part of the Kichler line of specialty landscape lighting.

To highlight the natural beauty and texture of trees within a landscape, the Kichler Long Cowl Mini-Accent Tree or

SYMBOL	DESCRIPTION	NOS.
•	GARDEN LUMINAIRE W/ EARTH SPIKE	51

NOTE:

Lighting Fixtures indicated are subject to availability and Landscape Architects recommendation.

SYMBOL	DESCRIPTION	NOS.
•	POLE FLOODLIGHT (SINGLE HEAD)	6

NOTE:

Lighting Fixtures indicated are subject to availability and Landscape Architects recommendation.





ADJUSTABLE EXTERIOR LED SPIKE SPOT Black or Grey Finish

DESCRIPTION

which is suitable for either vailable in a black or grey powder coated finish.

head can be angled to allow you to position the light exactly where you want it (90-degree tilt and 330-degree

all enough to create an impact but not too big to ne and out of place when unlit.

The 127mm ground spike allow you to easily place this fitting in

omplete with an 8.1 watt high-powered warm white LED, oviding energy efficient light for 40,000 hours.

P65 rated making the perfect choice for outdoor use, whether it be in your flower bed or to highlight a garden ornament.





Court Light

Wattage

400 or 1000 Head Options Single or Double Head Fixtures

3.5"x 3.5"

Pole Size Height

Pivoting base makes it easy to change light bulbs

Republic of the Philippines Office of the President

PREPARED BY : JANSEN GABRIEL S. LIM PREPARED BY : OHN W PACETE ARCHITECT

DATE :

ENGR. MARK P. TORRES

APPROVED AND REVIEWED BY

PROJECT TITLE :

LOCATION: PASONG TAMO EXTENSION, TAGUIG CITY

"STP, ACCESS ROAD AND FREEDOM PARK"

SHEET CONTENT : LANDSCAPE LIGHTING DETAILS SCALE : SHEET NO.

A-8.4

SYMBOL	DESCRIPTION	NOS.
•	RECESS FLOOR UPLIGHTS	90

NOTE: Lighting Fixtures indicated are subject to availability and Landscape Architects recommendation.

SYMBOL	DESCRIPTION	NOS.
	DECORATIVE GARDEN POLE LUMINAIRE	70

NOTE: Lighting Fixtures indicated are subject to availability and Landscape Architects recommendation.
STYLISH MODERN LAMP-POST - COMMERCIAL OR DOMESTIC USE







GU10 STAINLESS STEEL BEZEL GROUND LIGHT Shallow Ground Light for GU10 Base Lamps

This buried uplight is designed to operate with GU10 base mains lamps. We recommend using an energy-saving LED variation of this lamp, still mains operated but with more benefits such as long operating life, lower running costs and a choice of warm or daylight colour temperature.

Pre-wired with 1 metre of rubber cable to the terminal box, easy installation with loop out facility from 3 way terminal box.

Easy lamp change - use the Allen key supplied to unscrew the 3 screws which will give access to the lamp holder.

Designed for use with GU10 base mains lamps up to 50w.



White, Black or Aluminium ESCRIPTION

The diffuser on this light is not etched but the light is refracted off a cylinder of aluminium expanded metal which looks very effective

Available in a matt white, matt black or aluminium. Provides a stylish method for illuminating the exterior of your property, particularly well when used in conjunction with the other lamps in

Lamp holder accepts a single GU10 base mains lamp. We would recommend using a LED lamp.

If you are bolting this into concrete you will need to use expansion bolts, which you will either need to source, or contact us for advice.

If you are not bolting this into concrete, a Concrete Free Foundation Sub-Base Fixture is available - see accessories below.

IP44 rated providing protection from water spray in every direction.

NOTE:

Lighting Fixtures indicated are subject to availability and Landscape Architects recommendation.




PREPARED BY : APPROVED AND REVIEWED BY : PROJECT TITLE : PREPARED BY : SHEET CONTENT : SCALE : SHEET NO. LANDSCAPE LIGHTING DETAILS A-8.5 "STP, ACCESS ROAD AND FREEDOM PARK" JOHN V. PACETE ENGR. MARK P. TORRES JANSEN GABRIEL S. LIM PING AND SOCIAL SUPPORT DEPARTMENT DATE : LOCATION: PASONG TAMO EXTENSION, TAGUIG CITY REVISION NO.



LARGE TREES - 25 Nos.

COTTON TREE (Bombax Ceiba)

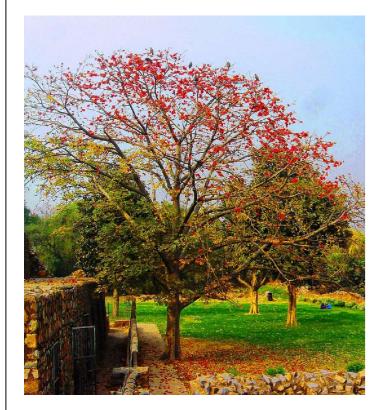



Bombax ceiba grows to an average of 20 meters, with old trees up to 60 meters in wet tropical regions. It has a straight tall trunk and its leaves are deciduous. Red flowers with 5 petals appear in the spring before the new foliage.

Trees indicated are subject to availability and Landscape Architects recommendation. 4" diameter at least on an average subject to the approval of BCDA (Height, Size, Species).



MEDIUM SIZE TREES - 15 Nos.

GOLDEN SHOWER (Cassia fistula)





DESCRIPTION: The Golden Shower is an erect, medium-sized tree, which sheds its leaves every year. The tree is found all over the Philippines. Commonly used as an ornamental tree.

Trees indicated are subject to availability and Landscape Architects recommendation. 4" diameter at least on an average subject to the approval of BCDA (Height, Size, Species).



SMALL SIZE TREES - 2 Nos.

PINK TABEBUIA (Tabebuia rosea)





DESCRIPTION:

Tabebuia rosea is a small tree, also called pink poui, and rosy trumpet tree is a neotropical treethat can grow up to 5 meters in height.

NOTE:

Trees indicated are subject to availability and Landscape Architects recommendation. 4" diameter at least on an average subject to the approval of BCDA (Height, Size, Species).



ACCENT TREES - 38 Nos.

llang-ilang (Cananga odorata)





llang-ilang is a medium-sized tree growing 10 to 30 meters in height, with pendulous branches, with drooping, leafy twigs. Flowers are fragrant, axillary, in umbellate hanging clusters, with three sepals and six petals, twisted when young and drooping when mature.

NOTE:

Trees indicated are subject to availability and Landscape Architects recommendation. 4" diameter at least on an average subject to the approval of BCDA (Height, Size, Species).

SHEET CONTENT:



PREPARED BY : PREPARED BY : ENGR. MARK P. TORRES JANSEN GABRIEL S. LIM OIC - ENGINEERING AND SOCIAL SUPPORT DEPARTMEN DATE :

"STP, ACCESS ROAD AND FREEDOM PARK"

SHEET NO. SCALE: PLANTING DETAILS A-8.6

LOCATION: PASONG TAMO EXTENSION, TAGUIG CITY

PROJECT TITLE :



PA - PLANTING AREA (SHRUBS)

Eugenia (Eugenia)



Shrubs indicated are subject to availability and Landscape Architects recommendation.



PA - PLANTING AREA (SHRUBS)

Hibiscus (Hibiscus)



Shrubs indicated are subject to availability and Landscape Architects recommendation.









DESCRIPTION:

Eugenia is a genus of flowering plants in the myrtle family Myrtaceae. It has a worldwide, although highly uneven, distribution in tropical and subtropical regions.

DESCRIPTION:

Gumamela in the Philippines comes in a variety of color and this tropical beauty is a sight to behold for their large showy flowers. And it can definitely enhance the beauty of any landscape and butterflies, bees, and birds are attracted to it.



PA - PLANTING AREA (SHRUBS)

Bougainvillea (Bougainvillea)

NOTE:

Shrubs indicated are subject to availability and Landscape Architects recommendation.



PA - PLANTING AREA (SHRUBS)

Pandacaqui (Tabernaemontana)

NOTE:

Shrubs indicated are subject to availability and Landscape Architects recommendation.









DESCRIPTION:

The flowers are more than the leaves when it blooms during the summer months, Its trunk is big as fists and has thorns, flowers grow in a variety of colors. Requires little maintenance and is commonly seen along streets in the metro.

DESCRIPTION:

LOCATION: PASONG TAMO EXTENSION, TAGUIG CITY

PROJECT TITLE :

Crape jasmine or Pandacaqui in the Philippines. A stunning shrub that can reach up to 2 m. tall, branches grow parallel to the ground giving it a unique and attractive look. The flowers are waxy, sweet-smelling, and white with 5 petals which are abundant throughout the year. It easily propagates through sunlight and regular watering.



JANSEN GABRIEL S. LIM ENGINEER

PREPARED BY :

PREPARED BY:

JOHN VEACETE

ARCHITECT

DATE:

ENGR MARK P. TORRES

DIC - ENGINEERING AND SOCIAL SUPPORT DEPARTMEN

"STP, ACCESS ROAD AND FREEDOM PARK"

PLANTING DETAILS

SHEET CONTENT

SCALE: SHEET NO.
NTS

A-8.7

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LW - LAWN (GRASS / GROUND COVER)

PEANUT PLUNT (Arachis pintoi)

NOTE:

Ground Cover indicated are subject to availability and Landscape Architects recommendation.



LW - LAWN (GRASS / GROUND COVER)

MANILA LAWN GRASS (Zoysia Matrella)

NOTE:

Ground Cover indicated are subject to availability and Landscape Architects recommendation.



DESCRIPTION:

This wild perennial relative of the groundnut or peanut, has been of increasing importance to pasture improvement in the tropics



DESCRIPTION:

commonly known as Manila grass, is a species of mat-forming, perennial grass native to temperate coastal southeastern Asia and northern Australasia.



RIVERSTONES

NOTE:

River Stones indicated are subject to availability and Landscape Architects recommendation.





USE:

Multi-colored river stones, from 50 up to 100 mm diameter loosely laid on site. Check commercial availability to be approved by Landscape Architect.



HEDGE PLANTING

KAMUNING (Murraya paniculata)

NOTE:

Shrubs indicated are subject to availability and Landscape Architects recommendation.





DESCRIPTION:

Kamuning is often grown as a hedge and it is widely planted in tropics and subtropics as an ornamental. It is commonly found in thickets and secondary forest throughout the Philippines.



PREPARED BY:

PREPARED BY:

APPROVED AND REVIEWED BY:

APPROVED AND REVIEWED BY:

FIGURE ARCHITECT

DATE:

DATE:

DATE:

DATE:

DATE:

APPROVED AND REVIEWED BY:

APPROVED AND REVIEWED

"STP, ACCESS ROAD AND FREEDOM PARK"

SHEET CONTENT :
PLANTING DETAILS


SCALE :

A-8.8

SHEET NO.

LOCATION: PASONG TAMO EXTENSION, TAGUIG CITY

PROJECT TITLE :

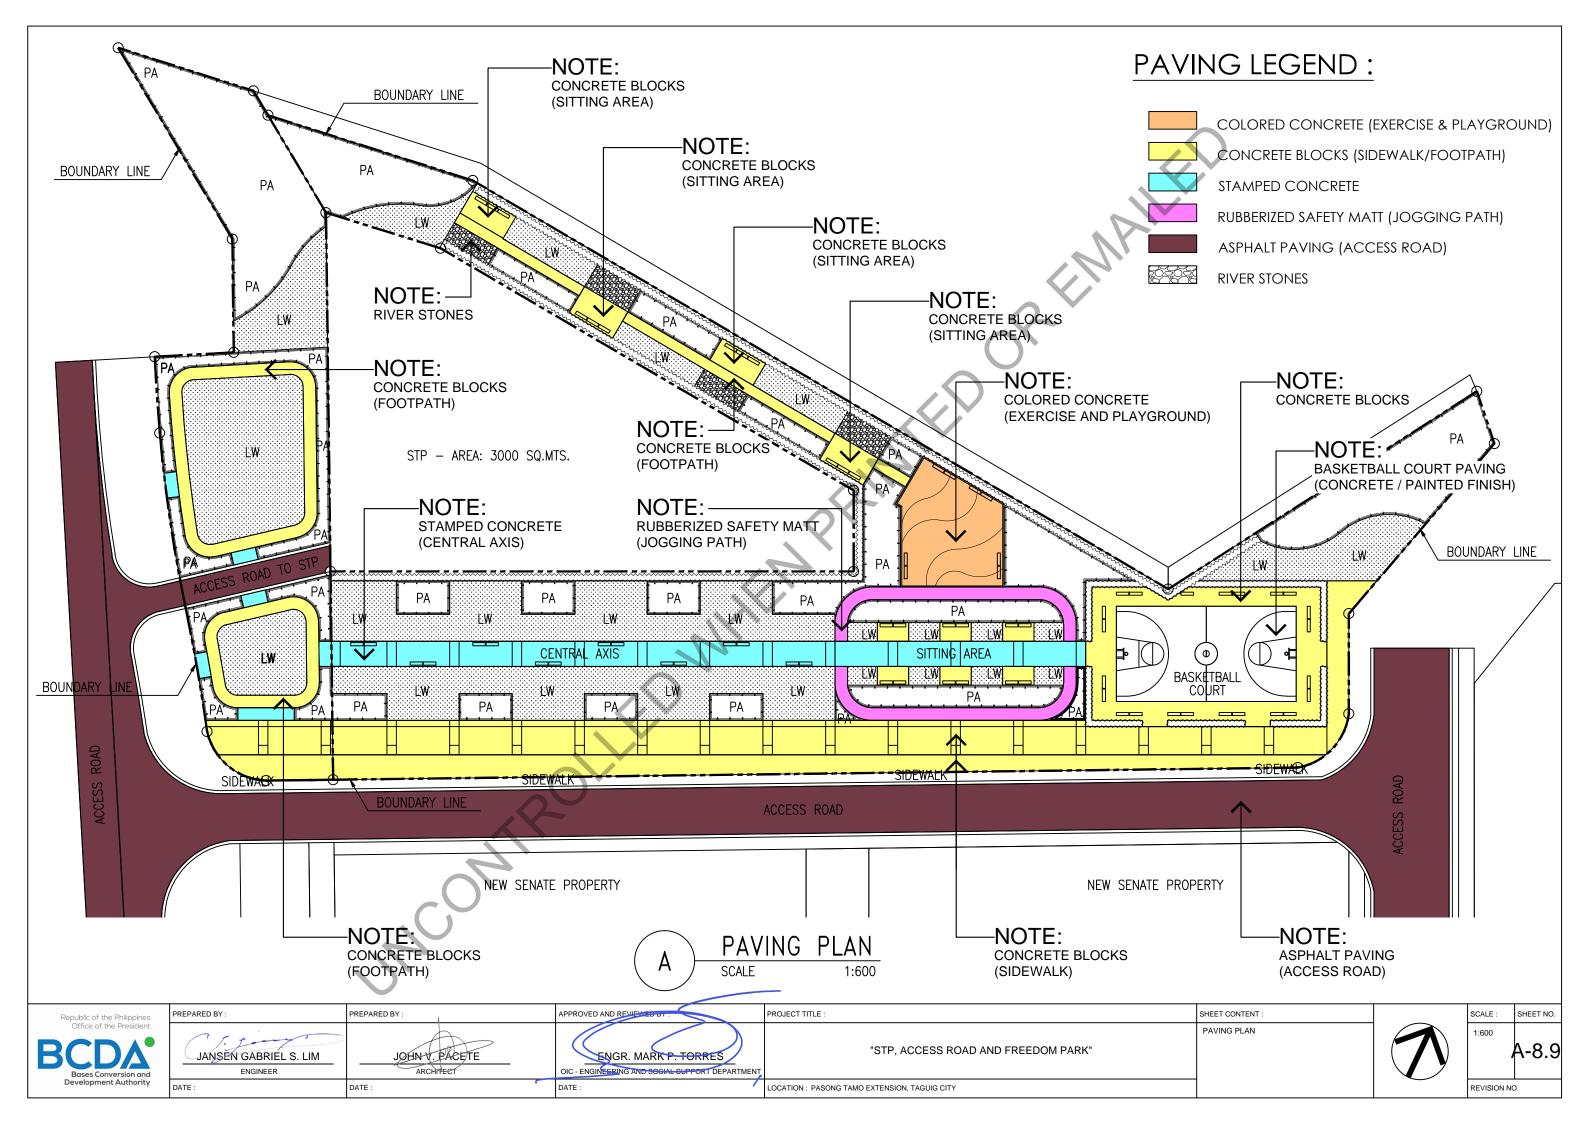







LEGEND	DESCRIPTION
	CONCRETE BLOCKS (SIDEWALK/FOOTPATH)











LEGEND	DESCRIPTION
	RUBBERIZED SAFETY MATT (JOGGING PATH)





LEGEND DESCRIPTION

ASPHALT PAVING (ACCESS ROAD)





PROJECT TITLE :

Republic of the Philippines
Office of the President

BCD

Bases Conversion and
Development Authority

ENGR. MARK P. TORRES
OIC - ENGREERING AND SOCIAL SUPPORT DEPARTMENT

"STP, ACCESS ROAD AND FREEDOM PARK"

SHEET CONTENT:

PAVING REFERENCE IMAGES

SCALE: SHEET NO.

NTS A-8.10

REVISION NO.

LOCATION : PASONG TAMO EXTENSION, TAGUIG CITY

EPDM SAFETY SURFACING FOR PLAYGROUNDS AND PLAY SPACES

THE UNIQUE INNOVATIVE TECHNOLOGY AND UNDENIABLE PRACTICALITY OF EPDM RUBBER GRANULES OPEN UP A WORLD OF DESIGN POSSIBILITY FOR PLAYGROUNDS AND PLAY SPACES.

EPDM Playground Surfacing. A poured-in-place, joint-free, porous material made from rubber granules and polyurethane binders uniquely designed to minimize injuries due to a fall. In accordance with European (EN) and US (ASTM) Standards, various thicknesses have been tested and awarded critical fall height ratings up to 10 feet (3 meters) – the maximum permitted falling height for modern play equipment. EPDM Playground Surfacing is our most cost-effective, all-weather safety surface for nearly anywhere aesthetics, comfort, and slip resistance are desired. Water drains rapidly through its coarse base layer to prevent freezing in the winter, making it a great choice for outdoor athletic tracks, walking paths, and patios. With its immense strength and durability, we can install EPDM Playground Surfacing directly on a crushed stone foundation. Compared to safety surfaces that require a separate substructure, this offers you a significant cost savings.

With additional options available such as EPDM Interactive Playground Surface and EPDM Play Surface with Recycled Materials, we have something to fit the community park, as well as the indoor sports athletic facility. Our team of designers and installers travel nationally and internationally to install safety surfacing where you live, where you rest, and where you play. Disney, Holiday Inn, Cedar Fair, and Great Wolf Lodge are a few of the companies that have chosen us for their safety surface needs.



01. RED

02. Green

03. Light Green

04. Blue

05. Light Blue

06. Orange

07. Yellow

08. Golden Yellow

09. Brown

10. Light Brown

11. Grey

12. Light grey

13. Eggshell

13. Eggshe 14. Pink

15. Purple

16. White 17. Green Grass

18. Navy Blue

19. Red Rose

EPDM COLOR CHART (JOGGING PATH)

SCALE :

AS SHOW


REVISION NO.

SHEET NO.

A-8.11



EPDM RUBBERIZED SAFETY MAT FOR JOGGING PATH

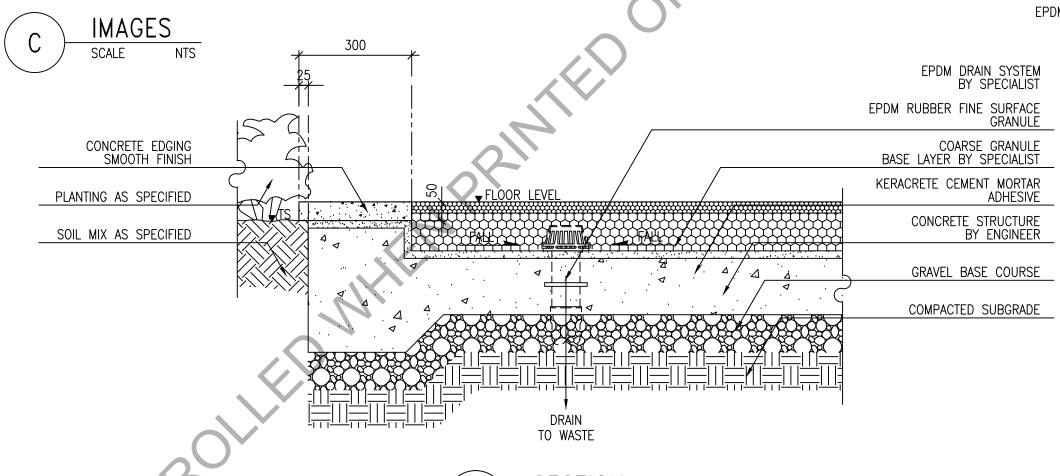







PREPARED BY: PREPARED BY: PROJECT TITLE: SHEET CONTENT:

JANSEN GABRIEL S. LIM
ENGINEER

DATE: PROJECT TITLE: PROJECT TITLE: SHEET CONTENT:

SHEET CONTENT:


SHEET CONTENT:

TYPICAL RUBBERIZED SAFETY MATT DETAIL

TYPICAL RUBBERIZED SAFETY MATT DETAIL

TOPICAL RUBBERIZED SAFETY MATT DETAIL

DATE: LOCATION: PASONG TAMO EXTENSION, TAGUIG CITY

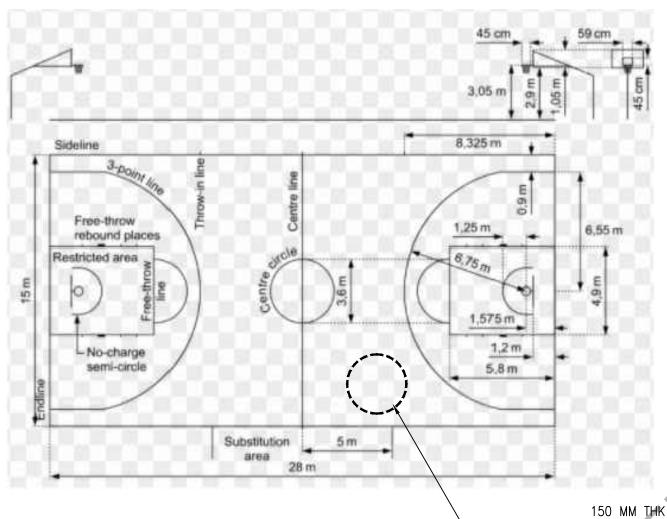

B PLAN SCALE NTS

150 MM THK SLAB 10 MM DIAM. REINFORCED BARS © 250 SPACING O.C. BOTH WAYS

C IMAGE SCALE NTS

-NOTE:

BASKETBALL COURT PAVING
(CONCRETE / PAINTED FINISH)

COURT				BASKETBALL.	BASKETBALL					
TYPE	L (FT)	W (FT)	TP (FT-IN.)	TYPE	MAX. GIAMETER (IN.)	MIN. DIAMETER (IN.)	MAX. WEIGHT (OZ	MIN. WEIGHT (OZ		
NBA	94	50	23-9 R	NBA	30 -	20.5	22	29		
International	94	50	2061 R	International	30	29.5	22	29		
NCAA (meri)	94	50	15-9 R	NCAA (men)	10	29.5	72	26		
MNBA, NCAA (women)	94	50	150 R	WNBA, NCAA (wemen)	19	28.5	20	18		
High schoo (men)	84	50	15.9 R	High school (men)	30	29.5	22	20		
High school (women	84	50	15.9 R	High school (women)	100	28.5	20	18		
BASKETBALL, CO		point line								
BASKETBALI. CO		godi) die		400						

NOTE:

Basketball court should be of standard dimensions and materials. Subject to specialists recommendation, to be approved by BCDA.





BASKETBALL COURT DETAIL


SCALE AS SHOWN





pines	PREPARED BY :	PREPARED BY:	APPROVED AND REVIEWED BY :	PROJECT TITLE :	SHEET CONTENT:	SCALE :	SHEET NO.
n and	JANSEN GABRIEL S. LIM ENGINEER	JOHN V. FACETE ARCHITECT	ENGR. MARK P. TORRES OIC - ENGINEERING AND SOCIAL SUPPORT DEPARTMENT	"STP, ACCESS ROAD AND FREEDOM PARK"	BASKETBALL COURT DETAIL	NTS A	-8.12
nority	DATE :	DATE:	DATE :	LOCATION: PASONG TAMO EXTENSION, TAGUIG CITY		REVISION N	10.

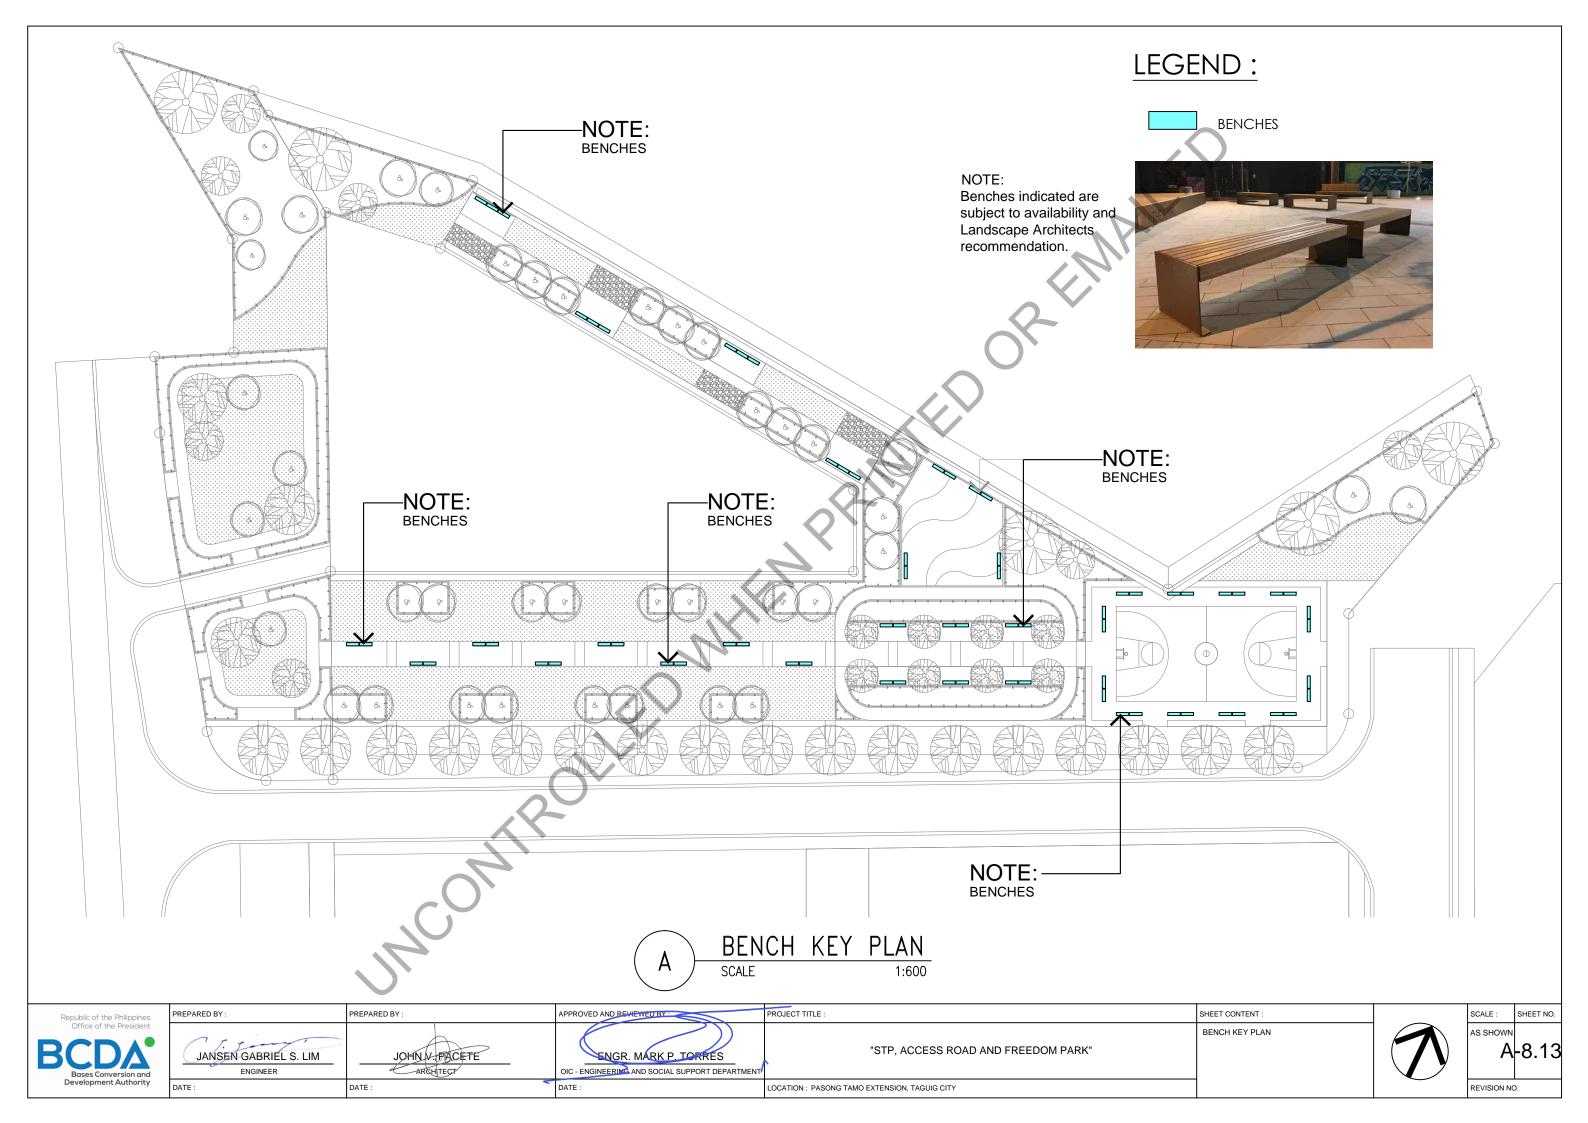

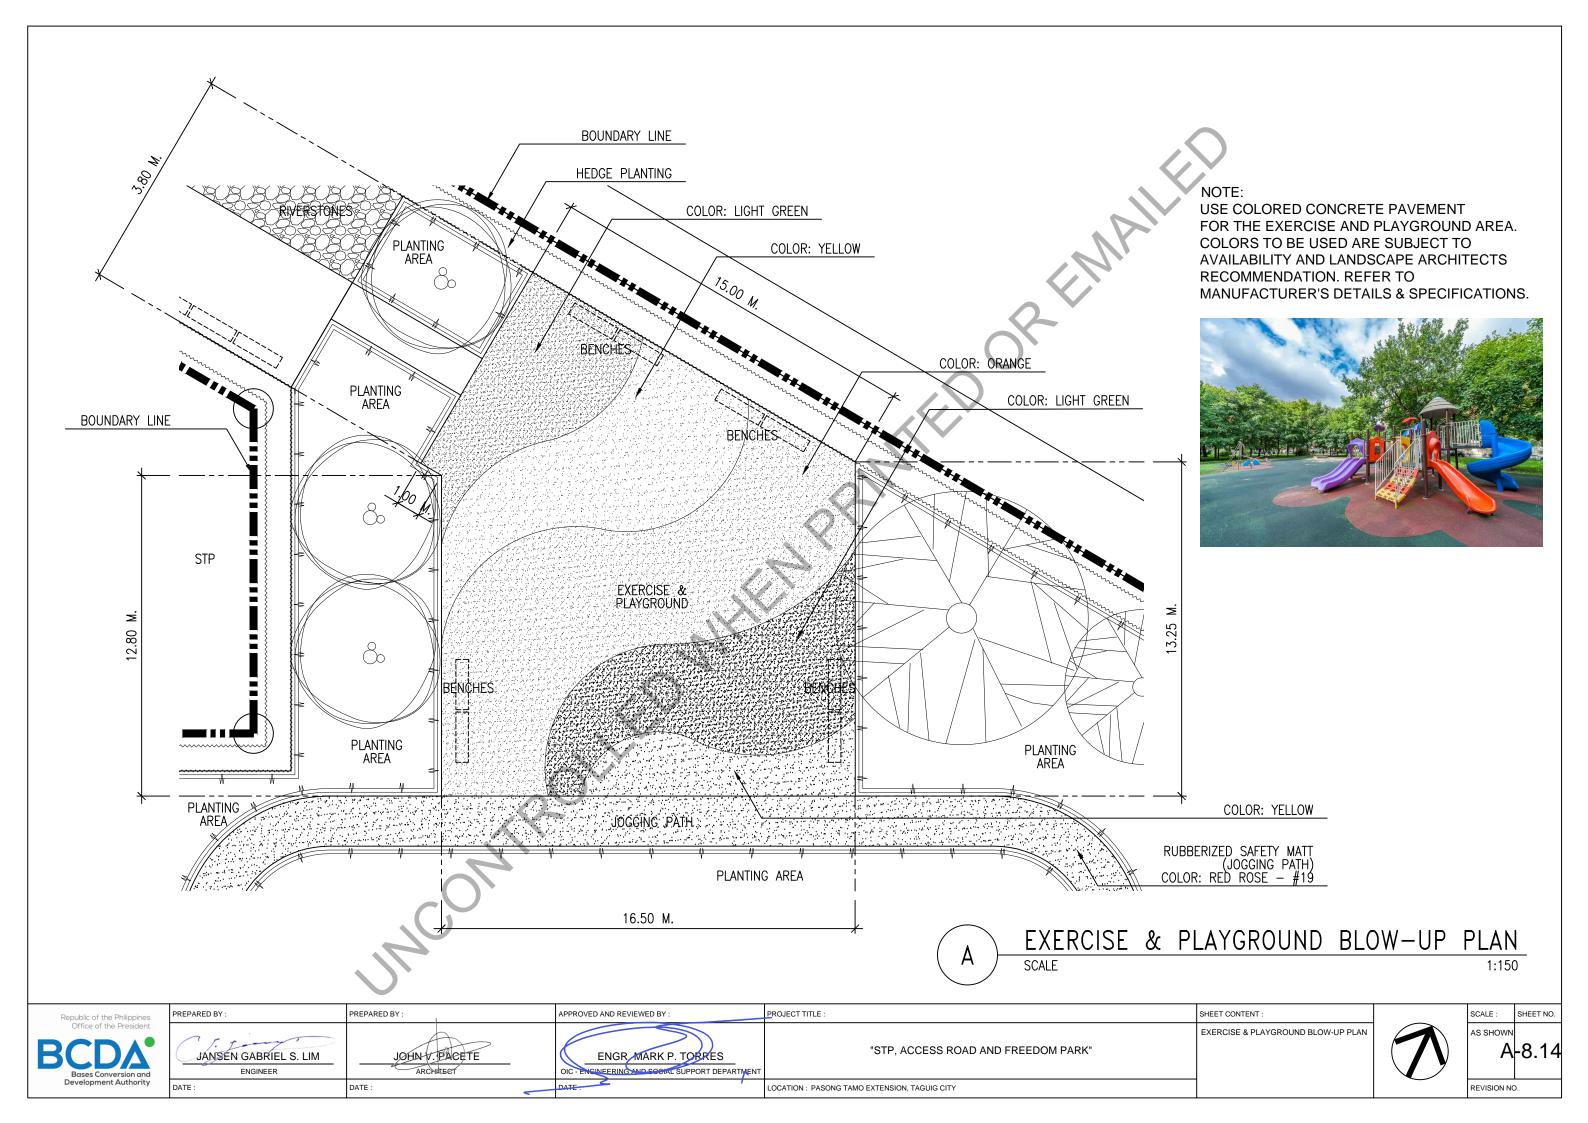

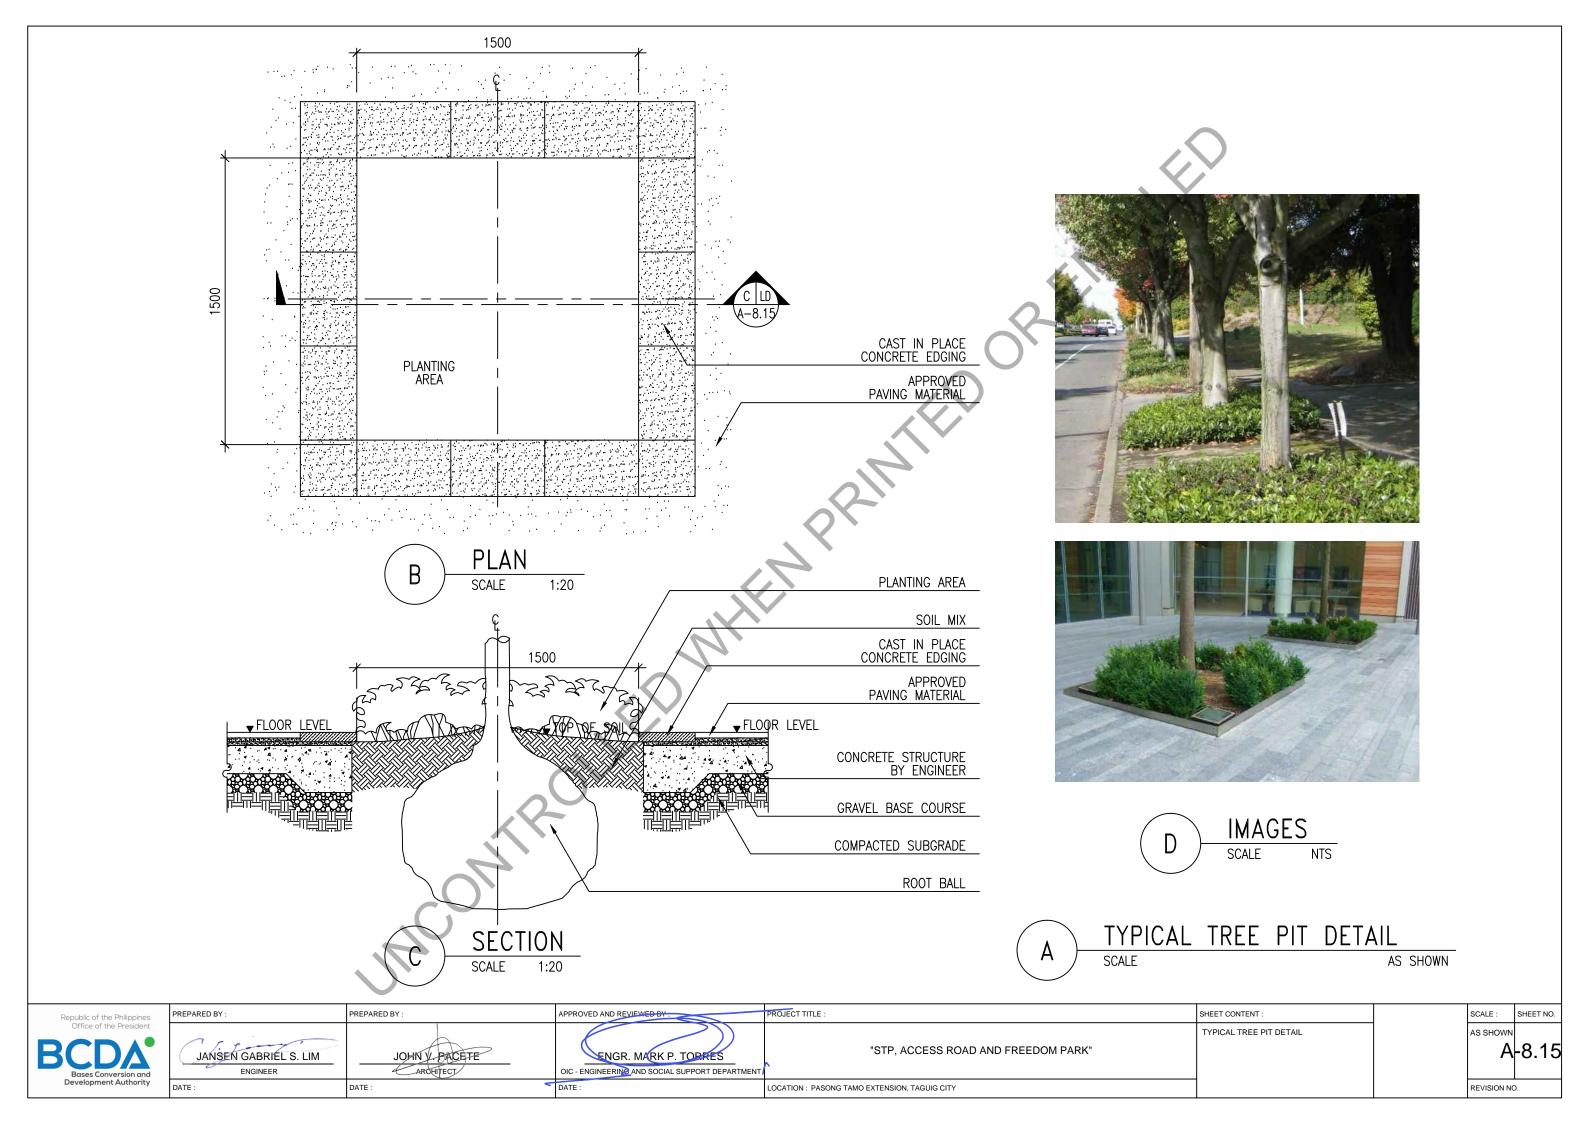

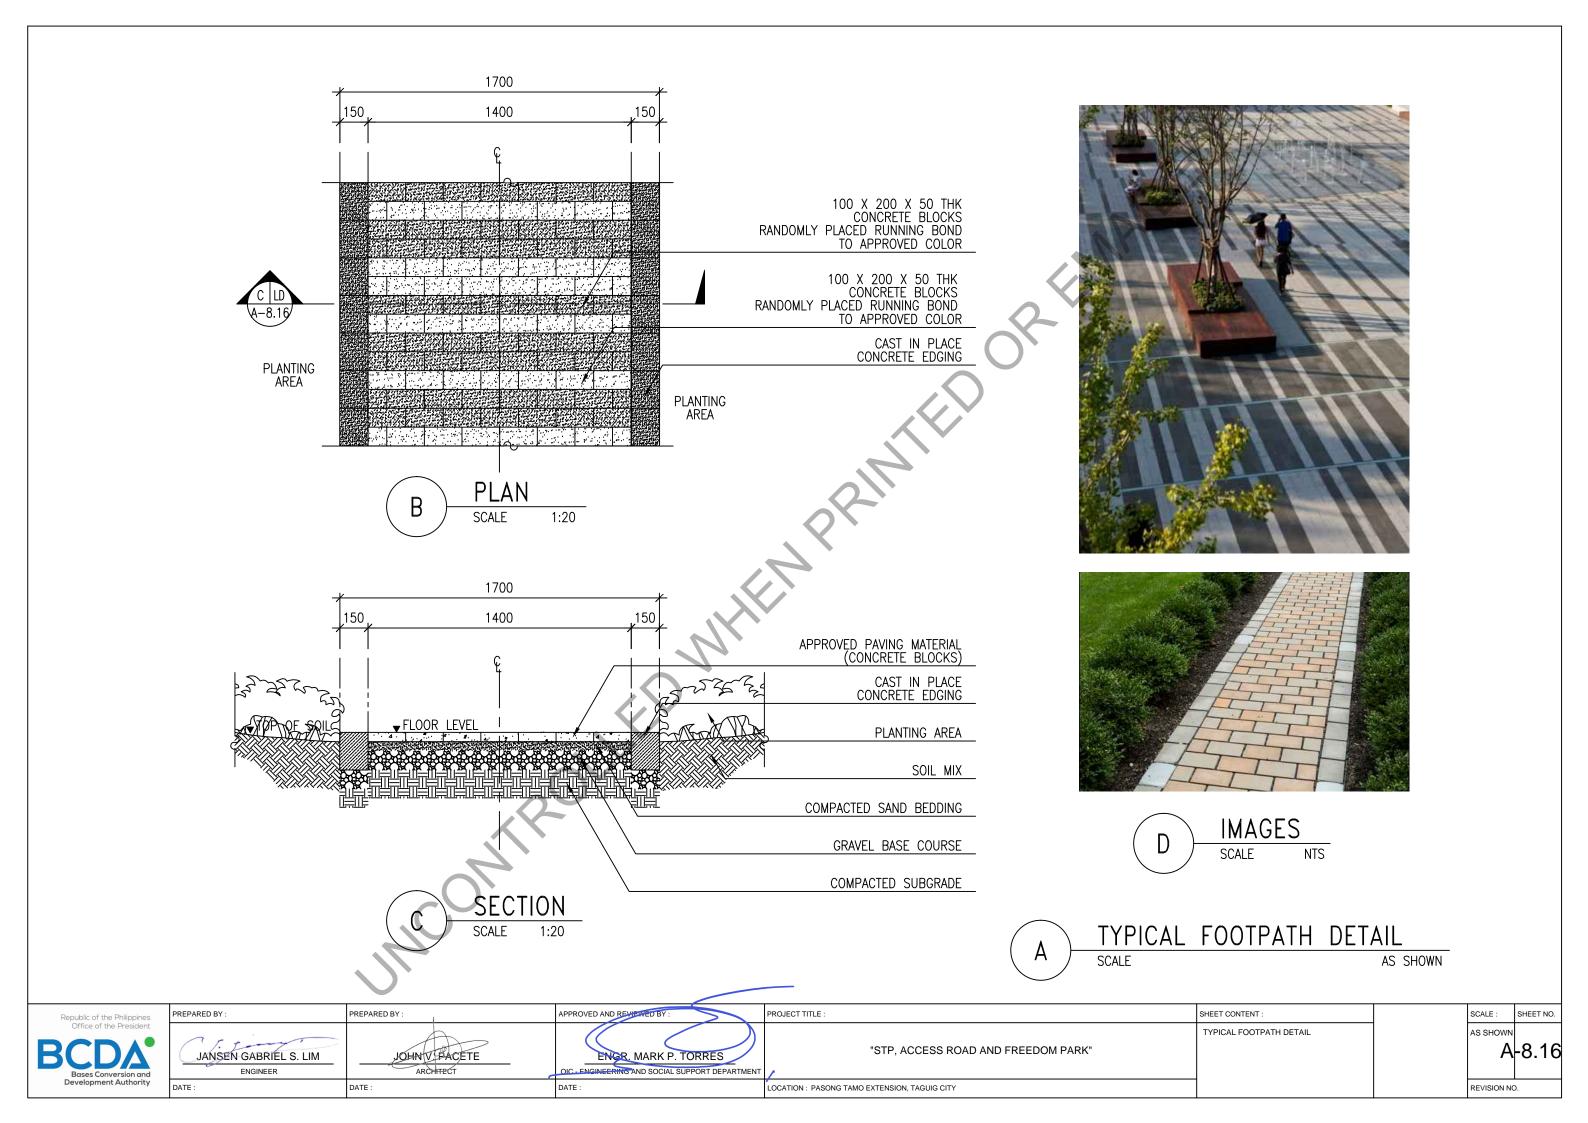

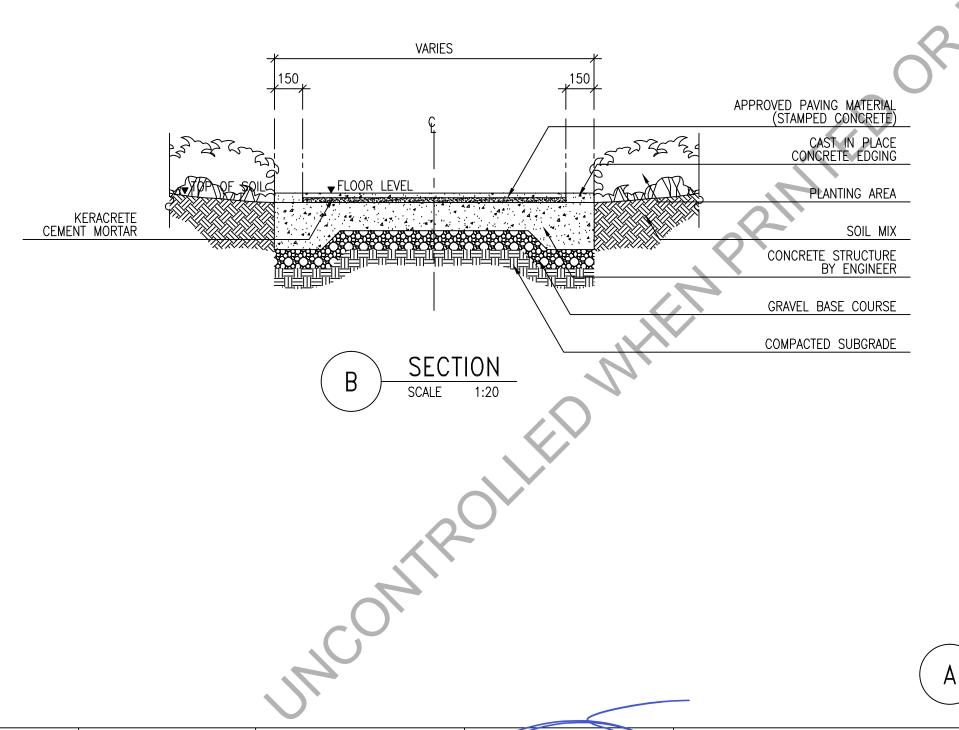





IMAGES SCALE




TYPICAL STAMPED CONCRETE DETAIL SCALE

AS SHOWN


Republic of the Philippines Office of the President

PREPARED BY : APPROVED AND REVIEWED BY PROJECT TITLE : PREPARED BY : SHEET CONTENT : TYPICAL STAMPED CONCRETE DETAIL JANSEN GABRIEL S. LIM "STP, ACCESS ROAD AND FREEDOM PARK" JOHN V. PACETE ENGR. MARK P. TORRES OIC - ENGINEERING AND SOCIAL SUPPORT DEPARTMEN DATE : DATE : DATE : LOCATION: PASONG TAMO EXTENSION, TAGUIG CITY

SCALE: SHEET NO. AS SHOWN A-8.17 REVISION NO.

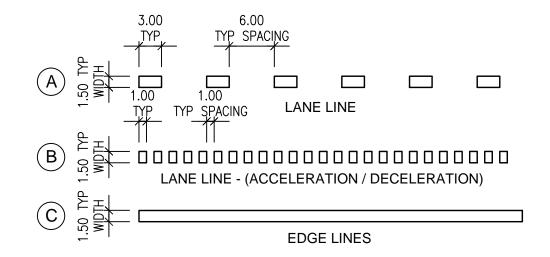



PAVEMENT MARKINGS								
SYMBOL	WIDTH	SPACING / SEGMENT / GAP	COLOR					
A	150	3.00 M. / 6.00 M.	WHITE					
B	150	1.00 M. / 1.00 M.	WHITE					
C	150	SOLID LINE	WHITE					

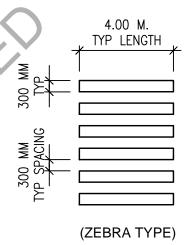

A	LANE	LINE	MARKING	DETAILS
A	SCALE			1:50


D PEDESTRIAN CROSSING DETAIL
1:100

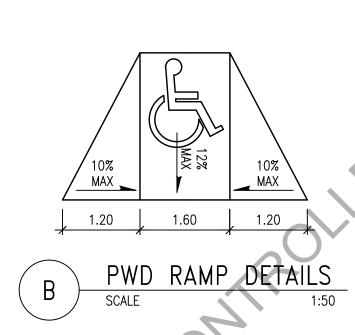


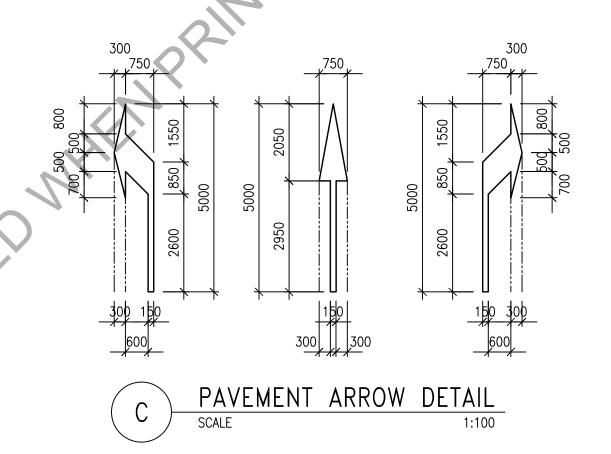




nes	PREPARED BY:	PREPARED BY:	APPROVED AND REVIEWED BY :	PROJECT TITLE :	SHEET CONTENT:	SCALE :	SHEET NO	4
ent	JANSEN GABRIEL S. LIM ENGINEER	JOHN V. PACETE ARCHIECT	ENGR. MARK P. TORRES OIC - ENSINEERING AND SOCIAL SUPPORT DEPARTMENT	"STP, ACCESS ROAD AND FREEDOM PARK"	PAVEMENT MARKINGS DETAIL	AS SHO	A-8.18	3
ity	DATE:	DATE :	DATE :	LOCATION : PASONG TAMO EXTENSION, TAGUIG CITY		REVISIO	N NO.	

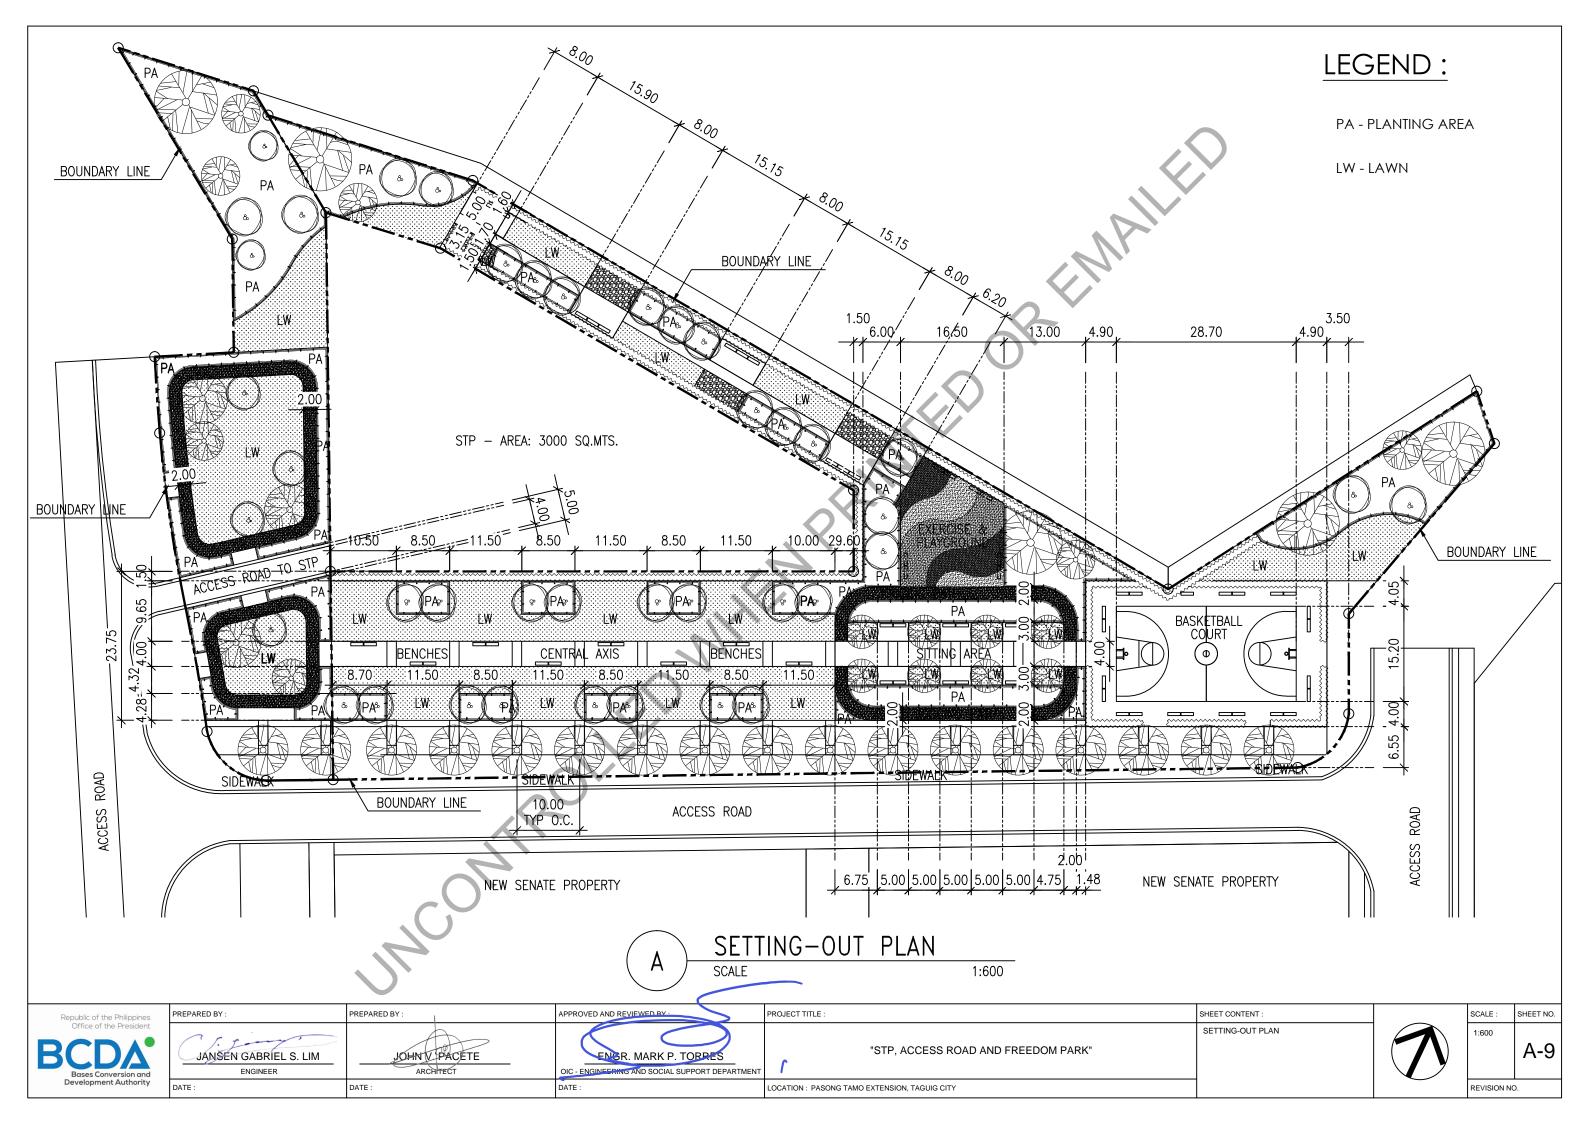

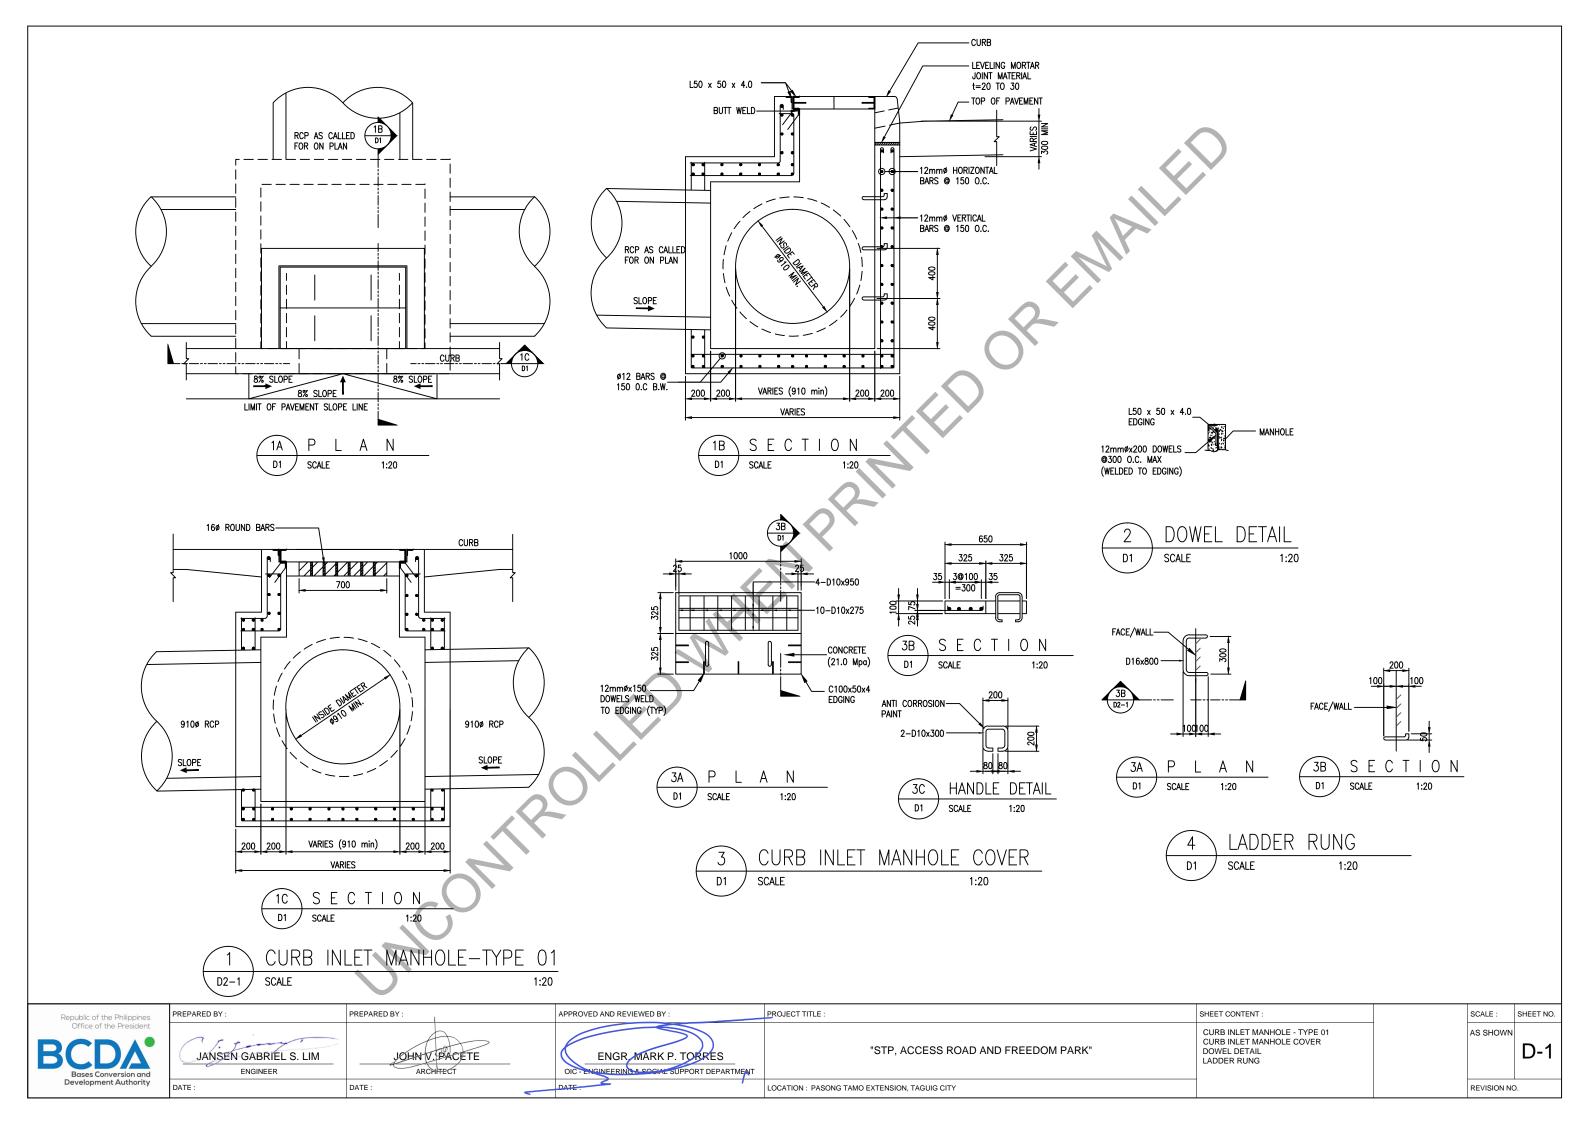

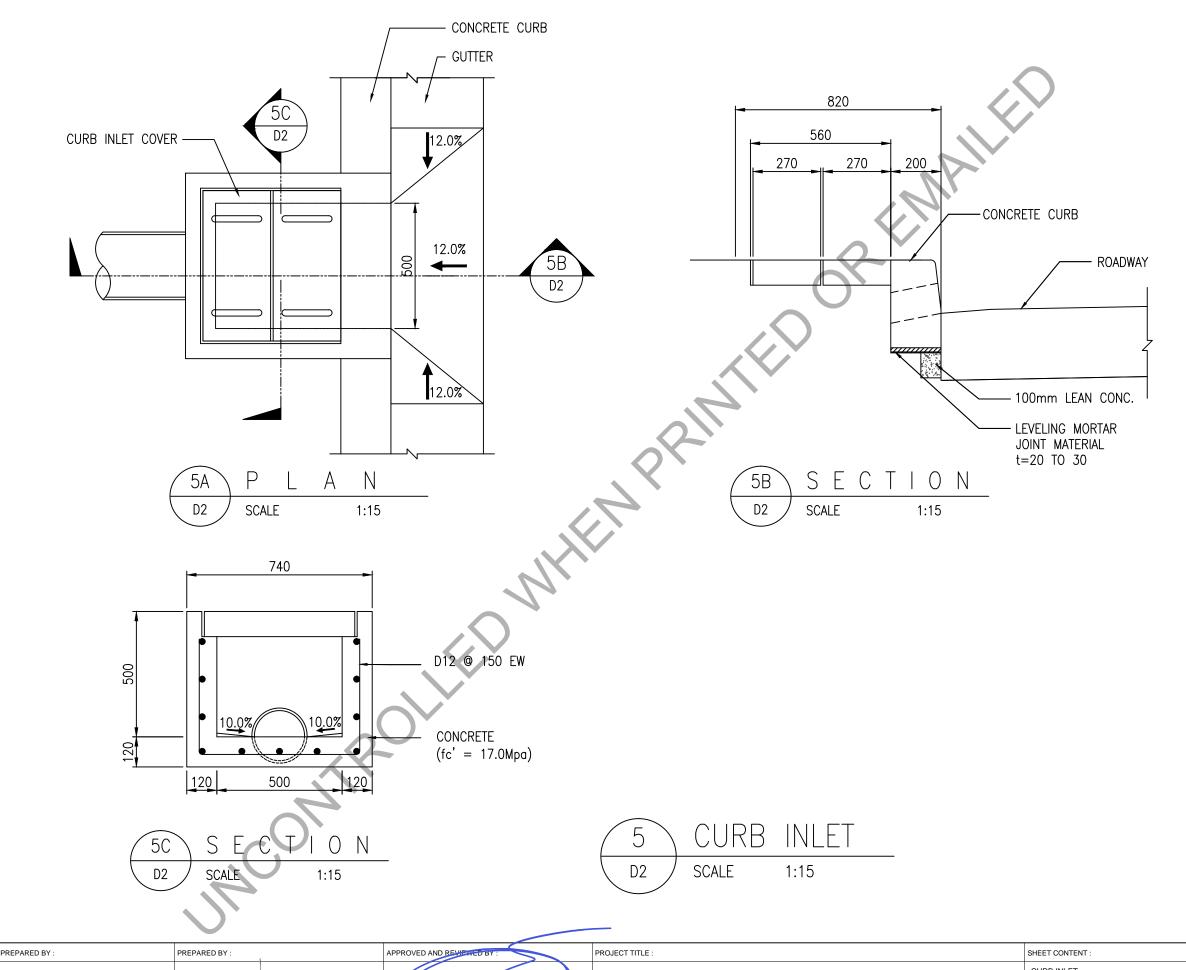


Republic of the Philippines Office of the President


JANSEN GABRIEL S. LIM ENGR. MARK P. TORRES JOHN V PACETE DATE :


CURB INLET "STP, ACCESS ROAD AND FREEDOM PARK" LOCATION: PASONG TAMO EXTENSION, TAGUIG CITY

SHEET NO. AS SHOWN D-2 REVISION NO.

SCALE:

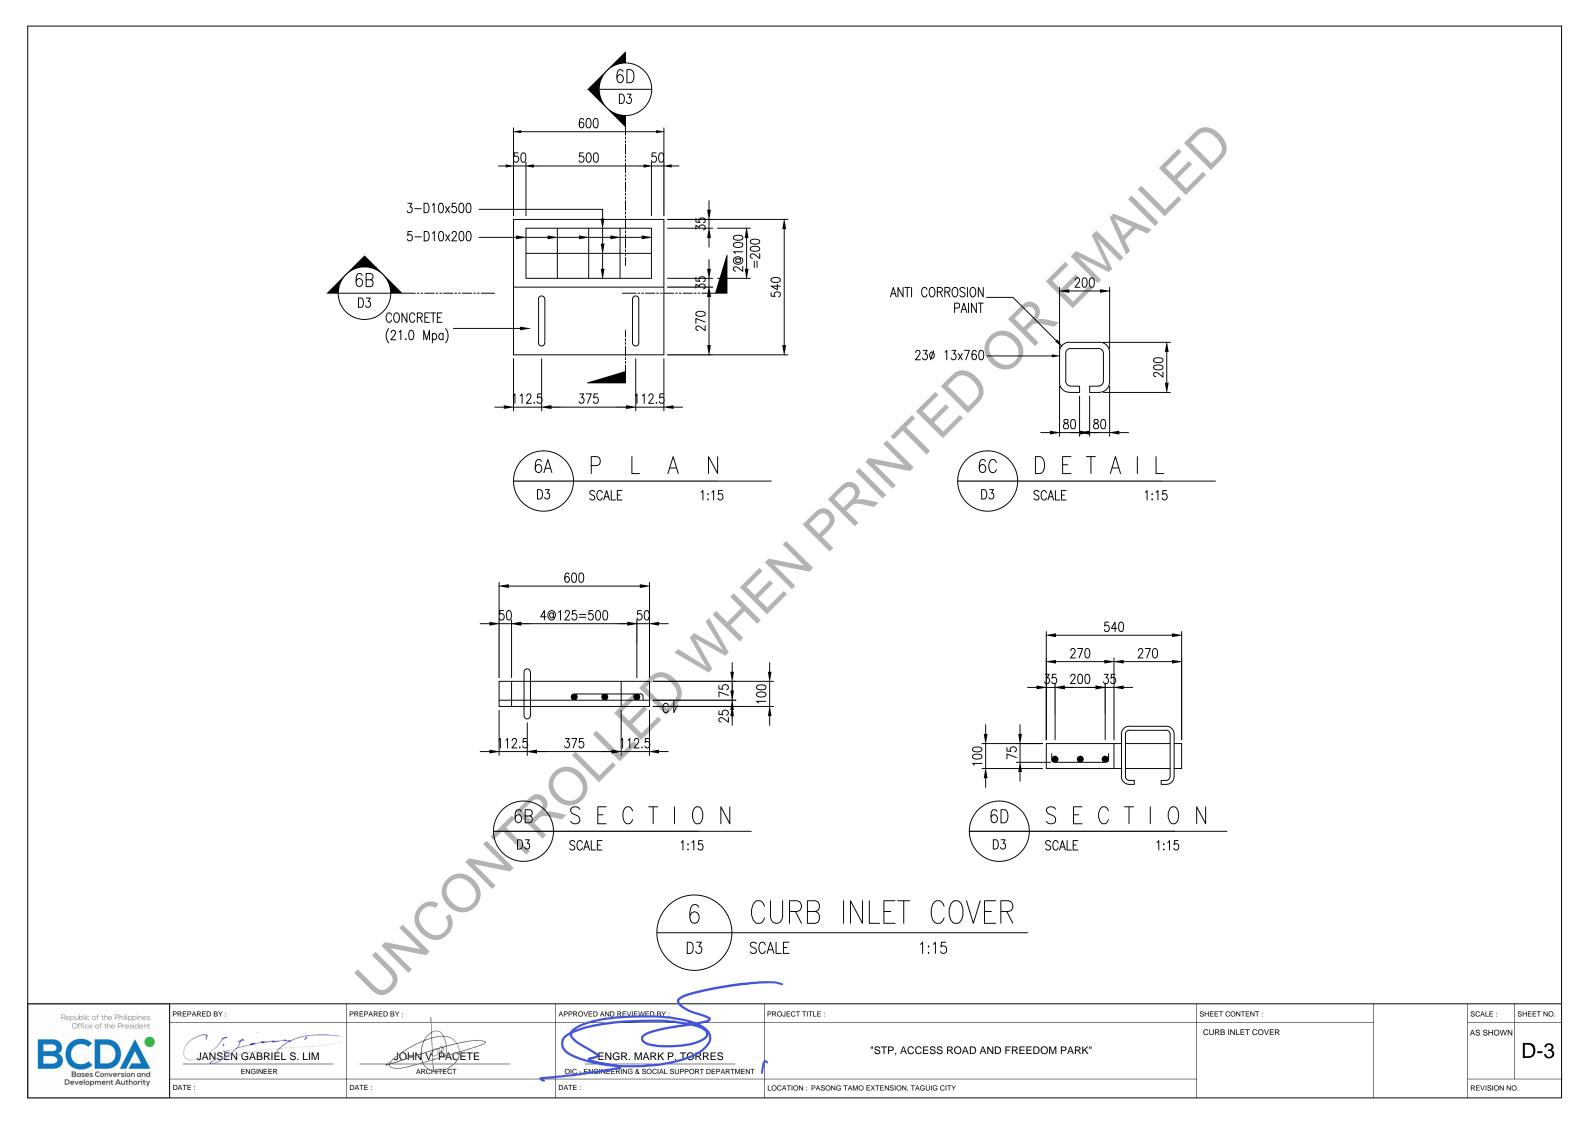

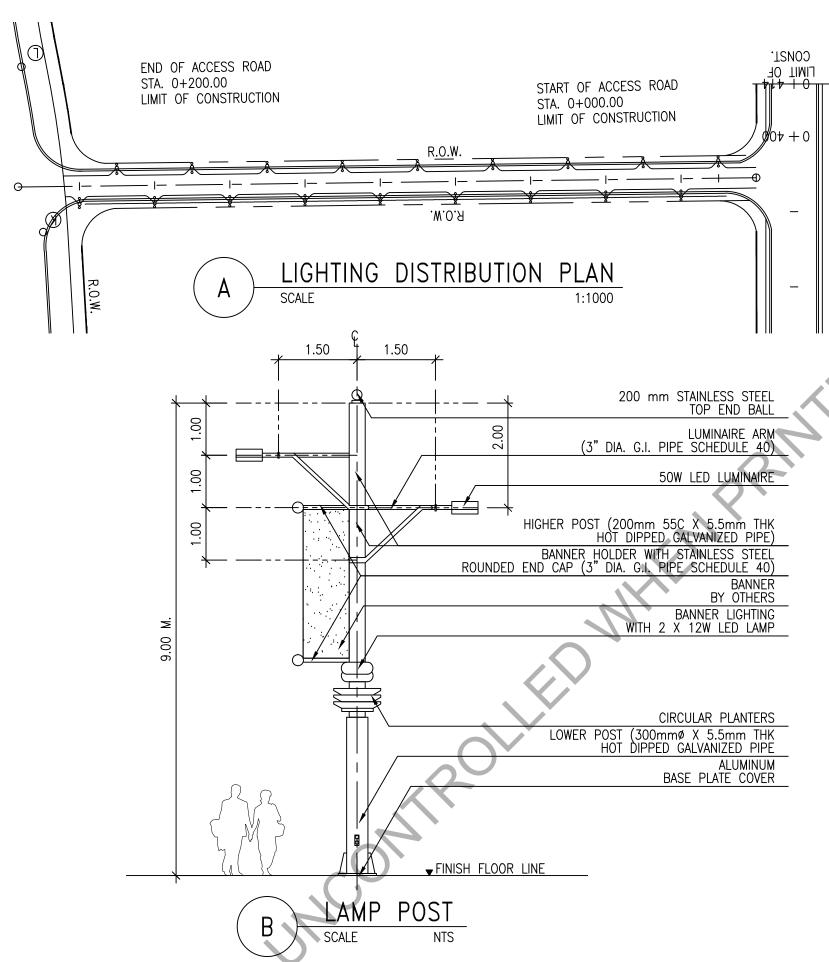

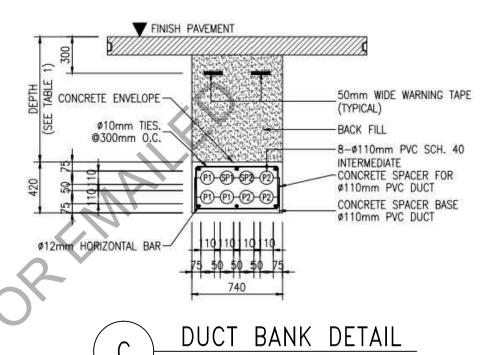

APPLICATION NOTES:

- THESE CONSTRUCTIVE UNITS ARE APPLICABLE TO BOTH 13.5kV U.G. LINES.
- 2. LABOR INCLUDES CLEANING OF DUCTS WITH MANDREL.
- ULTIMATE COMPRESSIVE STRENGTH OF CONCRETE SHALL BE 13.8 MPa.(2000psi).
- DUCTS SHALL BE SLOPED DOWN BY ATLEAST 0.25% TOWARDS MANHOLES OR PULLBOXES.
- THE CONDUIT CONCRETE ENCASEMENT SHALL HAVE 300mm MINIMUM VERTICAL CLEARANCE WHEN CROSSING OVER OR UNDER UTILITITIES AND 500mm HORIZONTAL CLEARANCE WHEN INSTALLED IN PARALLEL TO OTHER UNDERGROUND UTILITIES.
- WARNING TAPE SHALL BE HIGH GRADE LEAD FREE PIGMENTS, LOW DENSITY POLYETHYLENE POLYMERS AND RESISTANT TO MOST SOIL TYPES INCLUDING ALKALINE AND ACID SOILS.

TABLE 1

MINIMUM DEPTH	"D" IN MM
AREAS SUBJECT TO VEHICULAR TRAFFIC (SEE NOTE)	OTHER AREAS*
525	385

*MEASURED FROM TOP OF CONDUIT CONCRETE ENCASEMENT TO FINAL GRADE. NOTES:

AREAS SUBJECT TO VEHICULAR TRAFFIC ARE PUBLIC OR PRIVATE ROADS.
PARKING LOTS, OR OTHER AREAS SUBJECT TO USE BY CARS OR TRUCKS.

Republic of the Philippines
Office of the President

Bases Conversion and
Development Authority

PREPARED BY:

PREPARED BY:

APPROVED AND REVIEWED BY:

PROJECT TITLE:

SHEET CONTIL

LIGHTING D
LAMP POST
DUCT BANK

BY

DATE:

SHEET CONTIL

SHEET CONTIL

LIGHTING:

LIGHTING:

LAMP POST
DUCT BANK

DUCT BANK

DOCATION: PASONG TAMO EXTENSION, TAGUIG CITY


DATE:

SHEET CONTENT:

LIGHTING DISTRIBUTION PLAN
LAMP POST DETAIL
DUCT BANK DETAIL

SCALE: SHEET NO.
AS SHOWN
E-1

REVISION NO.

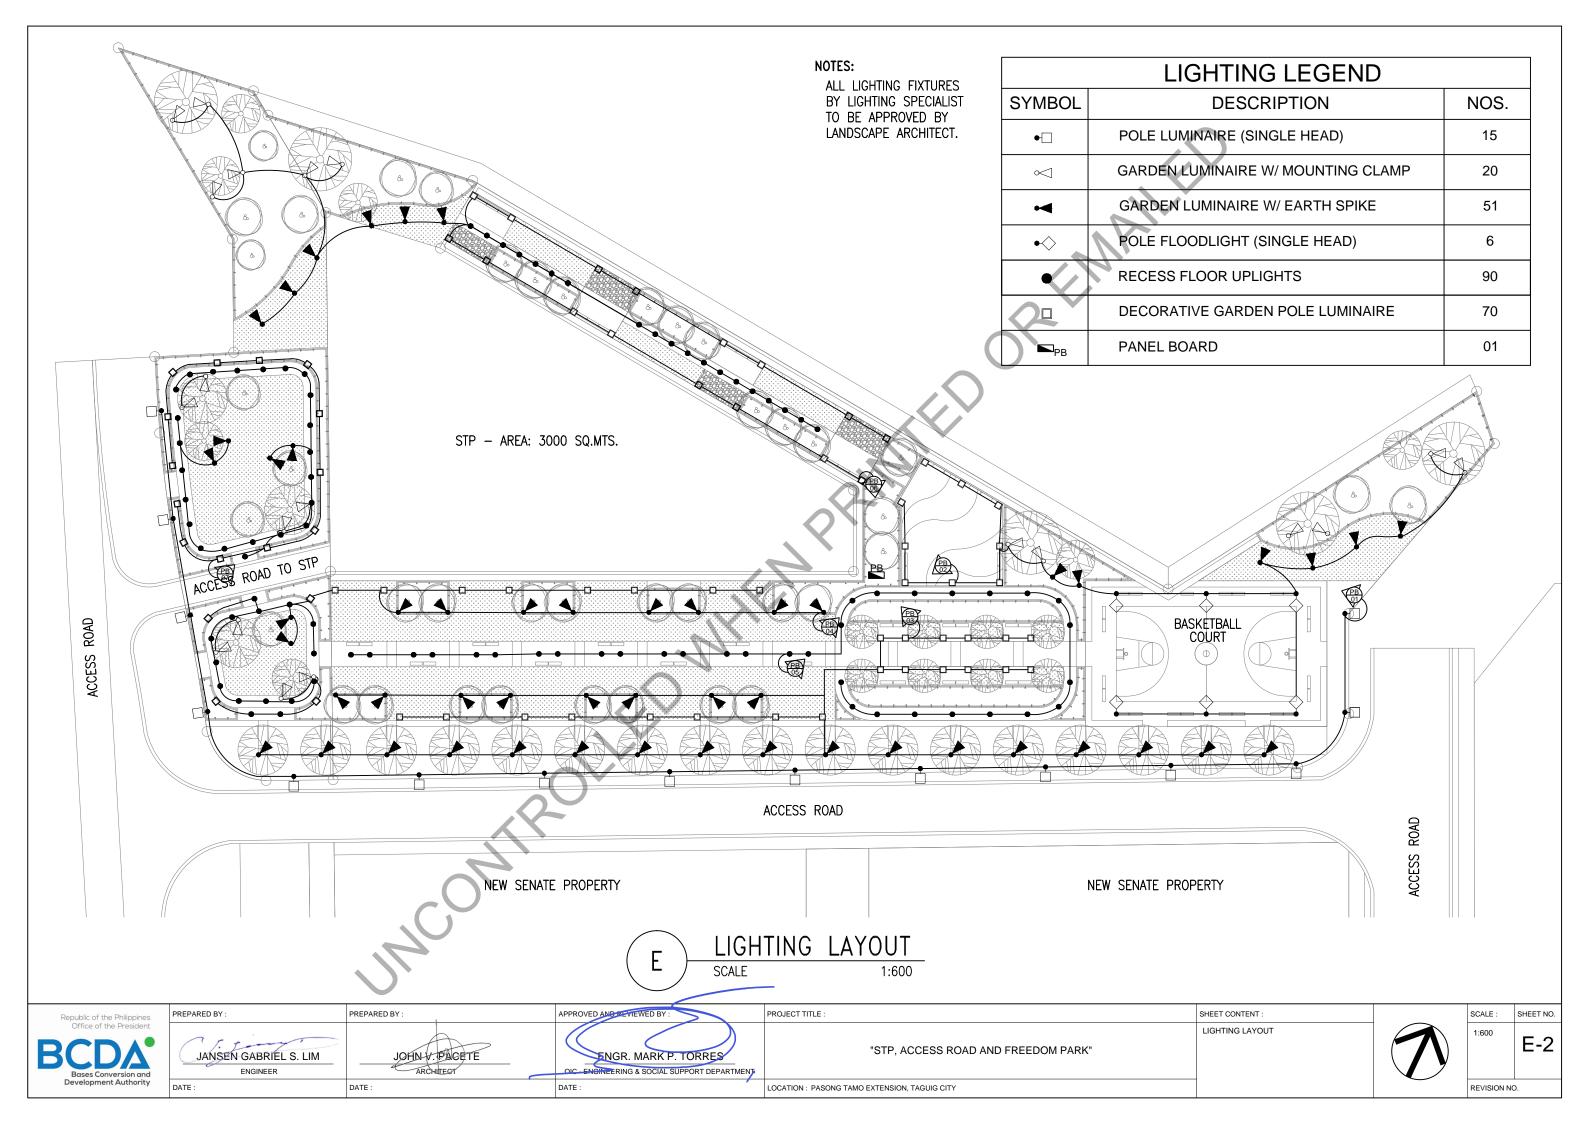

GENERAL NOTES

- 1. ALL ELECTRICAL WORKS SHALL BE DONE IN ACCORDANCE WITH THE PROVISION OF THE LATEST EDITION OF THE PHILIPPINE ELECTRICAL CODE (PEC). THE RULES AND REGULATIONS OF LOCAL AND NATIONAL AUTHORITIES CONCERNED WITH ENFORCEMENT OF RULES AND REGULATIONS OF LOCAL UTILITY COMPANY.
- 2. THE SERVICE VOLTAGE SHALL BE ONE PHASE, THREE WIRES, 230 VOLTS, 60 HERTZ SYSTEM.
- 3. THE INSTALLATION SHALL BE DONE AS FOLLOWS:
 - a. RIGID STEEL CONDUIT (RSC) ----- POWER SERVICE ENTRANCE FEEDERS
 - b. POLYVINYL CHLORIDE (PVC) ----- LIGHTING, POWER BRANCH CIRCUITS
- 4. TYPE "THW/THHN" UNLESS NOTED OTHERWISE SPECIFIED.
- ALL MATERIALS TO BE USED SHALL BE BRAND NEW AND OF THE APPROVED TYPE FOR THE LOCATION AND PURPOSED INTENDED.
- 6. THE MINIMUM SIZE OF WIRE AND CONDUIT TO BE USED SHALL BE 3.5 sqmm THHN AND 20 mm dia. RESPECTIVELY.
- 7. WHENEVER NECESSARY PULLBOX SHALL BE PROVIDED EVEN NOT INDICATED IN THE PLAN.
- 8. BRANCH CIRCUIT HOMERUNS SHALL NOT BE COMBINED IN THE SAME RACEWAY AND RACEWAY FOR AUXILIARY LINES SHALL NOT CONTAINS POWER LINES.
- 9. MOUNTING HEIGHTS SHALL BE AS FOLLOWS:
 - a. 1.70m ABOVE FLOOR FINISH@ CENTER ----- PANELBOARDS

DATE :

- b. ALL OTHER HEIGHTS ----- VERIFY TO THE ARCHITECT
- 10. ALL SERVICE ENTRANCE EQUIPMENTS SUCH AS PANELBOARD SHALL BE PROPERLY GROUNDED IN ACCORDANCE WITH THE PROVISION OF THE PHILIPPINE ELECTRICAL CODE. ALL ELECTRICAL WORKS AND INSTALLATIONS HEREIN SHALL BE DONE UNDER THE DIRECT SUPERVISION OF A DULY REGISTERED ELECTRICAL ENGINNER OR MASTER ELECTRICIAN.

PANEL BC	PANEL BOARD (PB) WITH PHOTOCELL & AUTOMATIC SWITCH TIMER								
CKT NO	LOAD DESCRIPTION	VA	V	Α	TRIP	Р	SIZE OF WIRES	CONDUIT	
01	LIGHTING OUTLET	3750	230	16.30	20	2	2-3.5mm ² THHN + 1-3.5mm ² THHN (G)	20mmø PVC	
02	LIGHTING OUTLET	3600	230	15.65	20	2	2-3.5mm ² THHN + 1-3.5mm ² THHN (G)	20mmø PVC	
03	LIGHTING OUTLET	4500	230	19.57	20	2	2-3.5mm ² THHN + 1-3.5mm ² THHN (G)	20mmø PVC	
04	LIGHTING OUTLET	4100	230	17.83	20	2	2-3.5mm ² THHN + 1-3.5mm ² THHN (G)	20mmø PVC	
05	LIGHTING OUTLET	3600	230	15.65	20	2	2-3.5mm ² THHN + 1-3.5mm ² THHN (G)	20mmø PVC	
06	LIGHTING OUTLET	4700	230	20.43	20	2	2-3.5mm ² THHN + 1-3.5mm ² THHN (G)	20mmø PVC	
07	LIGHTING OUTLET	4400	230	19.13	20	2	2-3.5mm ² THHN + 1-3.5mm ² THHN (G)	20mmø PVC	
08	SPARE								
	TOTAL	28650		124.56	•				

TOTAL CONNECTED LOAD

SIZE OF MAIN CIRCUIT BREAKER

SIZE OF MAIN FEEDERLINE

IFL = 124.56A + (25%) (20.43A)

IFL = 129.67A

IFL @ 85% DF = 129.67A x 0.85

IFL @ 85% DF = 110.22A

Floor Mounted Electrical Panel board Enclosure Weatherproof/Outdoor type with Photocell and Automatic Switch Timer

Use: 150AT, 100AF, 2P, 230V Center Main

Use: 2-38mm² THHN + 1-8.0mm² THHN (G) 50mmø RSC Pipe

SUMMY RSC PIPE

NOTE:

Tap to nearest distribution power supply





PREPARED BY:

APPROVED AND REVIEWED BY

JANSEN GABRIEL S. LIM

ENGINEER

ARCHITECT

APPROVED AND REVIEWED BY

FINGR. MARK P. TORRES

OIC - ENGINEERING & SOCIAL SUPPORT DEPARTMENT

PROJECT TITLE:

SHEET CONTENT:

GENERAL NOTES AND LOAD SCHEDULE

"STP, ACCESS ROAD AND FREEDOM PARK"

LOCATION: PASONG TAMO EXTENSION, TAGUIG CITY

SCALE: SHEET NO.

1:600 E-3

REVISION NO.







oines	PREPARED BY :	PREPARED BY :	APPROVED AND REVIEWED BY :	PROJECT TITLE :	SHEET CONTENT :	SCALE:	SHEET NO.
and	JANSEN GABRIEL S. LIM ENGINEER	JOHN PACETE ARCHIVEET	ENGR. MARK P. TORRES OIC - ENGINEERING AND SOCIAL SUPPORT DEPARTMENT	"STP, ACCESS ROAD AND FREEDOM PARK"	PERSPECTIVE 01	NTS	N-1
ority	DATE :	DATE:	DATE:	LOCATION: PASONG TAMO EXTENSION, TAGUIG CITY		REVISION N	10.





Republic of the Philippines
Office of the President

Bases Conversion and
Development Authority

PREPARED BY : PROJECT TITLE : PREPARED BY : APPROVED AND REVIEWED BY SHEET CONTENT : SHEET NO. PERSPECTIVE 02 N-2 "STP, ACCESS ROAD AND FREEDOM PARK" JANSEN GABRIEL S. LIM ENGR. MARK P. TORRES JOHN V. PACETE ENGINEERING AND SOCIAL SUPPORT DEPARTMENT DATE : LOCATION: PASONG TAMO EXTENSION, TAGUIG CITY REVISION NO.







nes	PREPARED BY :	PREPARED BY:	APPROVED AND REVIEWED BY PROJECT TITLE :		SHEET CONTENT:	SCALE	SHEET	NO.
ent	JANSEN GABRIEL S. LIM ENGINEER	JOHN V PACETE ARCHTECT	ENGR MARK P TORRES OIC - ENGINEPRING AND SOCIAL SUPPORT DEPARTMENT	"STP, ACCESS ROAD AND FREEDOM PARK"	PERSPECTIVE 03	NTS	N-	-3
and rity	DATE :	DATE :		TAMO EXTENSION, TAGUIG CITY	-	REVISIO	L ON NO.	_







oines	PREPARED BY:	PREPARED BY:	APPROVED AND REVIEWED BY:	PROJECT TITLE :	SHEET CONTENT:	SCALE:	SHEET NO.
dent					PERSPECTIVE 04	NTS	
	JANSEN GABRIEL S. LIM	JOHN V. PACETE	ENGR. MARK P. TORRES	"STP, ACCESS ROAD AND FREEDOM PARK"			N-4
and	ENGINEER	ARCHITECT	OIC - ENGINEERING AND SOCIAL SUPPORT DEPARTMENT				
ority	DATE:	DATE:	DATE:	LOCATION: PASONG TAMO EXTENSION, TAGUIG CITY		REVISION NO	Э.







oines	PREPARED BY:	PREPARED BY:	APPROVED AND REVIEWED BY:	PROJECT TITLE:	SHEET CONTENT :	SCALE :	SHEET NO.
dent	250				PERSPECTIVE 05	NTS	
	JANSEN GABRIEL S. LIM	JOHN V. PACETE	ENGR. MARK P. TORRES	"STP, ACCESS ROAD AND FREEDOM PARK"			N-5
and	ENGINEER	ARCHITECT	OIC - ENGINEERING AND SOCIAL SUPPORT DEPARTMENT				
ority	DATE:	DATE:	DATE :	LOCATION : PASONG TAMO EXTENSION, TAGUIG CITY		REVISION NO	Э.